
14 BAY ST, DOUBLE BAY COMMERCIAL + MULTI-RESIDENTIAL DEVELOPMENT

NO.	DRAWING NAME	SCALE
DA 1.00	Cover Page + Drawing List	NTS
DA 1.01	Context Analysis	1:4000
DA 1.02	Context Analysis - Built Form	NTS
DA 1.03	Site Analysis	1:500
DA 1.04	Existing Buildings + Controls	1:200
DA 1.05	Context - Recent Approvals	1:500
DA 1.06	Contect - Part Wall Conditions	NA
DA 1.07	Context - HOB Comparison	1:500
DA 1.08	Context - Unit 4.1 Terrace	1:200
DA 1.10	FSR Calculations	1:200
DA 2.00	Plan - Ground + Level 1	1:100
DA 2.01	Plan - Level 2 + 3	1:100
DA 2.02	Plan - Level 4 + Roof	1:100
DA 2.03	Plan Fsuperseded with DA2.02	1:100
DA 3.00	Elevations - Street	1:200
DA 3.01	Elevations - East + West	1:100
DA 3.02	Elevations - North	1:100
DA 3.03	Elevation - South	1:100
DA 3.04	Section A	1:100
DA 3.05	Section B	1:100
DA 3.06	Section A - Extended	1:100
DA 3.07	Elevations - Comparison Page	1:100
DA 4.00	Facade details + Materiality	1:50
DA 4.01	Photomontage	NTS
DA 5.00	Superseded with DA5.02 to DA5.04 21	1:500
DA 5.01	Solar Access - Proposed Equinox	1:500
DA 5.02	Hourly June 21 Shadows (Sheet 1)	1:500
DA 5.03	Hourly June 21 Shadows (Sheet 2)	1:500
DA 5.04	Hourly June 21 Shadows (Sheet 3)	1:500
DA 6.00	View Analysis 1 - Unit 4.1 Terrace East	NTS
DA 6.01	View Analysis 2 - Unit 4.1 Terrace East	NTS





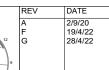

AMENDMENT DA SUBMISSION Joint Report Revised terrace to Bay Street

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PROJECT Bay Street 14 Bay St, Double Bay

Halepa Holdings

CLIENT

Cover Page + Drawing List						
JOB NO	DRAWN	SCALE	DRAWING NO.			
19.53	MR	1:2000	DA 1.00			
DATE	CHECKED	PLOT DATE	REVISION			
Sept 2020	PT	28/4/22	G			



ARCHITECTS:			RE,
La till della casta		N	А
1 02 9211 4276 1 02 9281 3171 – Dr. E admini®Hillhais.com.au – C Nominated Architects: Philip Thais #6780 Sarah Hill #5285 – C	ve figured dimensions only o not scale omply with the Building Code of Australia omply with the relevant Australian Standards omply with relevant Australian Excellatorements	3 6 0 0 0 0 0 0 0 0 0 0 0 0 0 0 0 0 0 0	F
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 DATE
 AMENDMENT

 2/9/20
 DA SUBMISSION

 19/4/22
 Joint Report



0005233910 29 Apr 2022 Assessor Padraig Healy Accreditation No. 101026 Address 14 Bay Street, Double Bay. NSW, 2028

5.3 Average star rating

HOUSE


PROJECT Bay Street 14 Bay St, Double Bay

CLIENT Halepa Holdings The site at 14 Bay Street is located in the important regional centre of Double Bay. Within a 5/10 minute / 400/800 metres are Edgecliff train station and bus interchange, the main Double Bay shopping areas, Edgecliff commercial centre and Double Bay Wharf. These centres contain many services for the benefit of residents and workers. Since the village of Double Bay was established in the 1830's, the area's urban development continues to evolve as a heterogeneous mix of major retail and entertainment, mixed use buildings of all types and sizes, with a range of apartment buildings and some remnant individual houses fringing the centre.


The site has easy access to Sydney's city centre, to multiple transport modes, shops, many public facilities and open spaces, and thus is well suited to this proposal as it provides high levels of amenity in an established and diverse neighbourhood.

taken from the **Design Quality Statement**

DRAWING TITLE					
Context Analysi					
JOB NO	DRAWN	SCALE	DRAWING NO.		
19.53	MR	1:4000@A3	DA 1.01		
DATE	CHECKED	PLOT DATE	REVISION		
Sept 2020	PT	19/4/22	F		

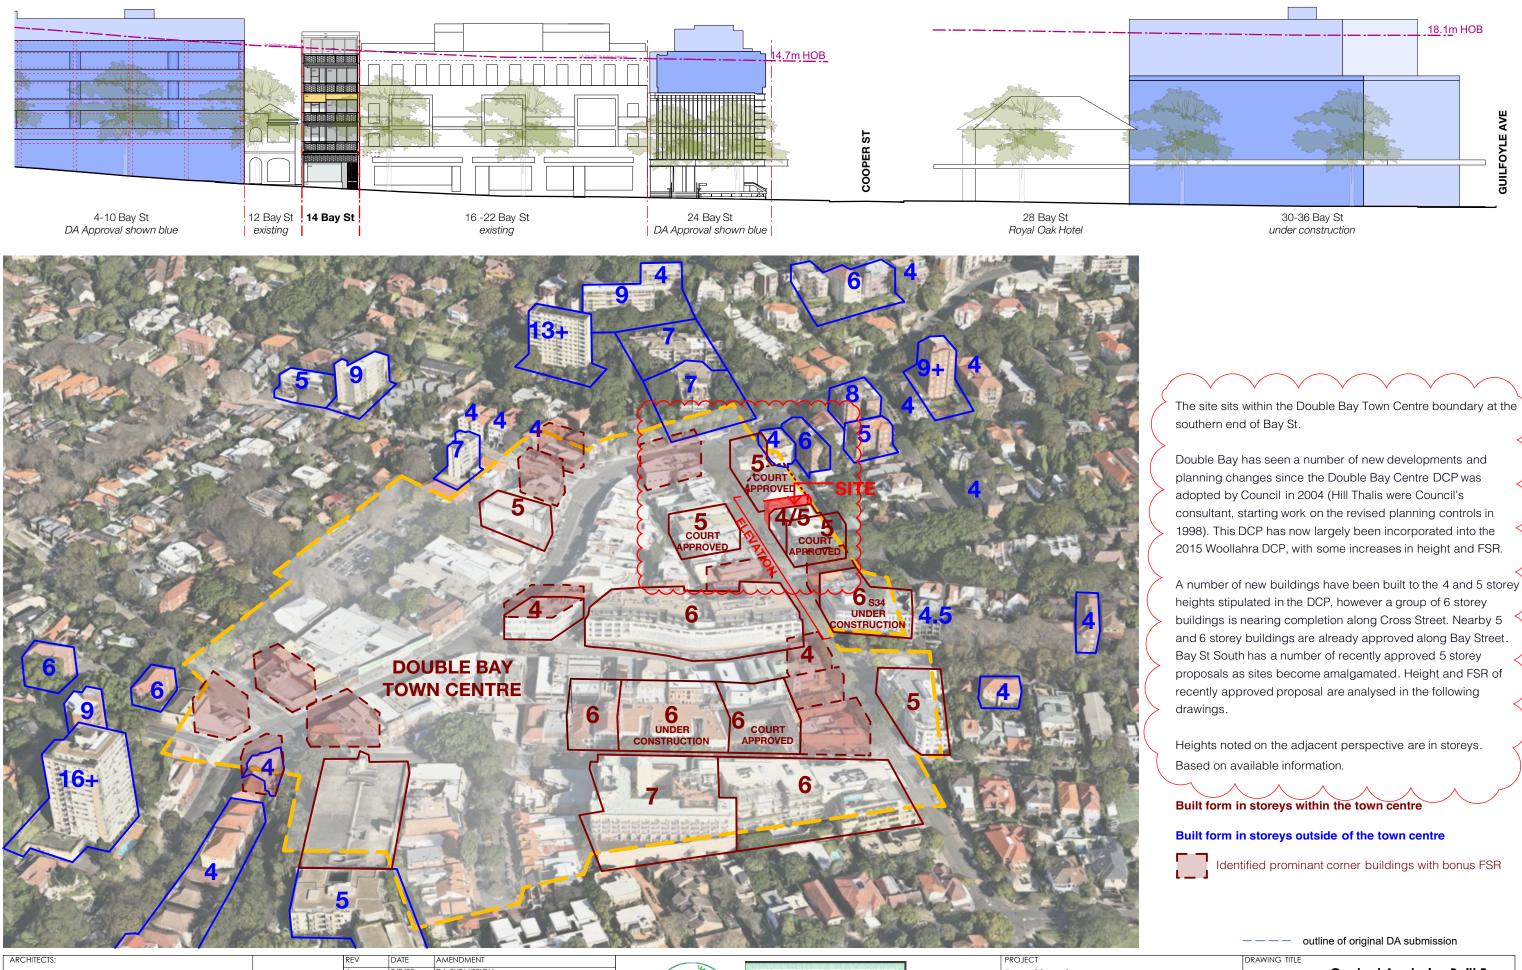

hill thalis	
EVEL 4, 45-72 Wenhwarth Ave Suny Hills NSW 2010. Australia To 22 2011 4276 F (02 298) 3171 E administrillithalis.com.au Nominated Architects: Philip Thalis #6780 Sarah Hill #5285	 Use figured dimensions only Do not scale Comply with the Building Code of Australia Comply with the relevant Australian Standards Comply with relevant Australiae's requirements
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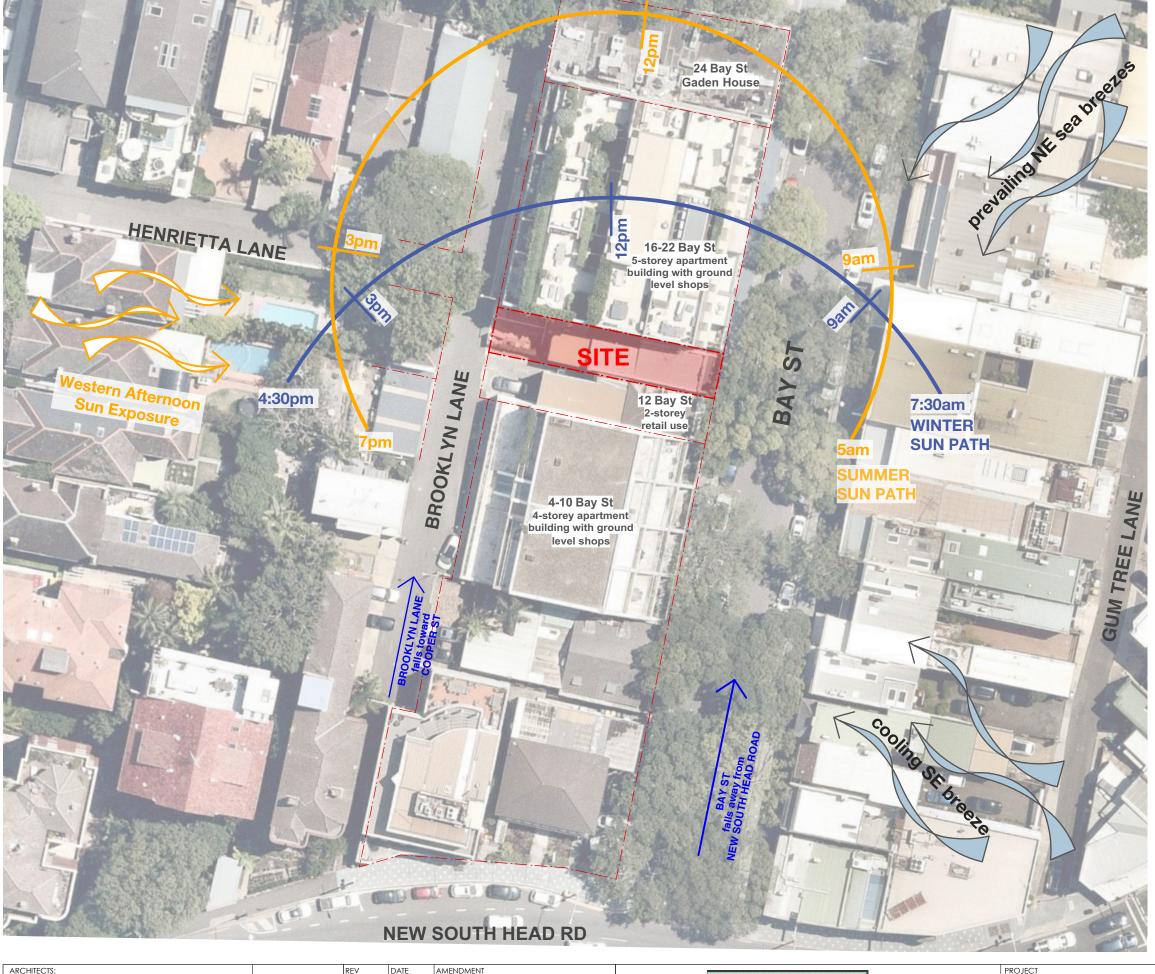


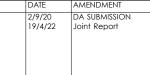Bay Street 14 Bay St, Double Bay


CLIENT Halepa Holdings

The site sits within the Double Bay Town Centre boundary at the

Context Analysis - Built Form						
ob no	DRAWN	SCALE	DRAWING NO.			
9.53	MR	1:400 Section	DA 1.02			
DATE	CHECKED	PLOT DATE	REVISION			
ept 2020	PT	19/4/22	F			
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hill thalis		
RCHITECTURE + URBAN PROJECTS PTY LTD		
VEL 4, 68-72 Wentworth Ave ny Hills NSW 2010 Australia		Use figured dimensions only
	-	
2 9211 6276 F 02 9281 3171	-	Do not scale
dmin@hillthalis.com.au_www.hillthalis.com.au	-	Comply with the Building Code of Australia
minated Architects: Philip Thalis #6780 Sarah Hill #5285	-	Comply with the relevant Australian Standards
	-	Comply with relevant Authorities' requirements



DATE AMENDMENT 2/9/20 DA SUBMISSION 19/4/22 Joint Report

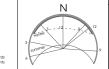

5.3 Average Star faile Network PROJECT
Bay Street
14 Bay St, Double Bay
CLIENT

Halepa Holdings

Bay St







Brooklyn Lane



DRAWING TITLE			
	Site Analysis		
JOB NO	DRAWN	SCALE	DRAWING NO.
19.53	MR	1:500@A3	DA 1.03
DATE	CHECKED	PLOT DATE	REVISION
Sept 2020	PT	19/4/22	F

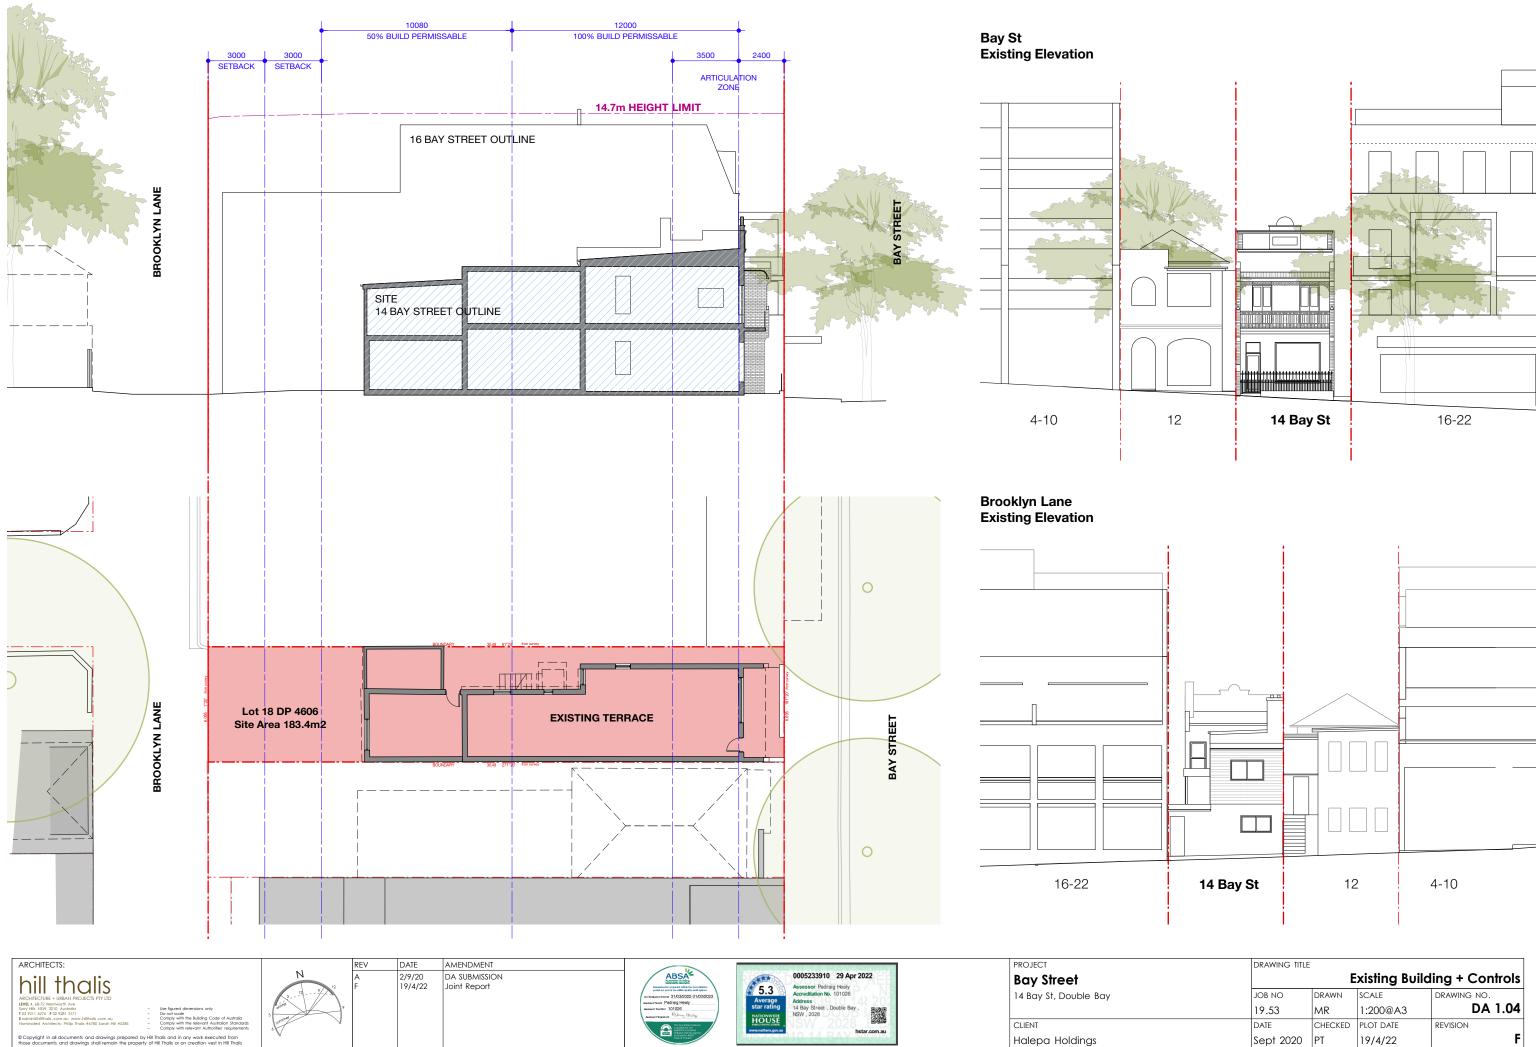

DRAWING TITLE						
Existing Building + Controls						
JOB NO	DRAWN	SCALE	DRAWING NO.			
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DATE	CHECKED	PLOT DATE	REVISION			
Sept 2020	PT	19/4/22	F			

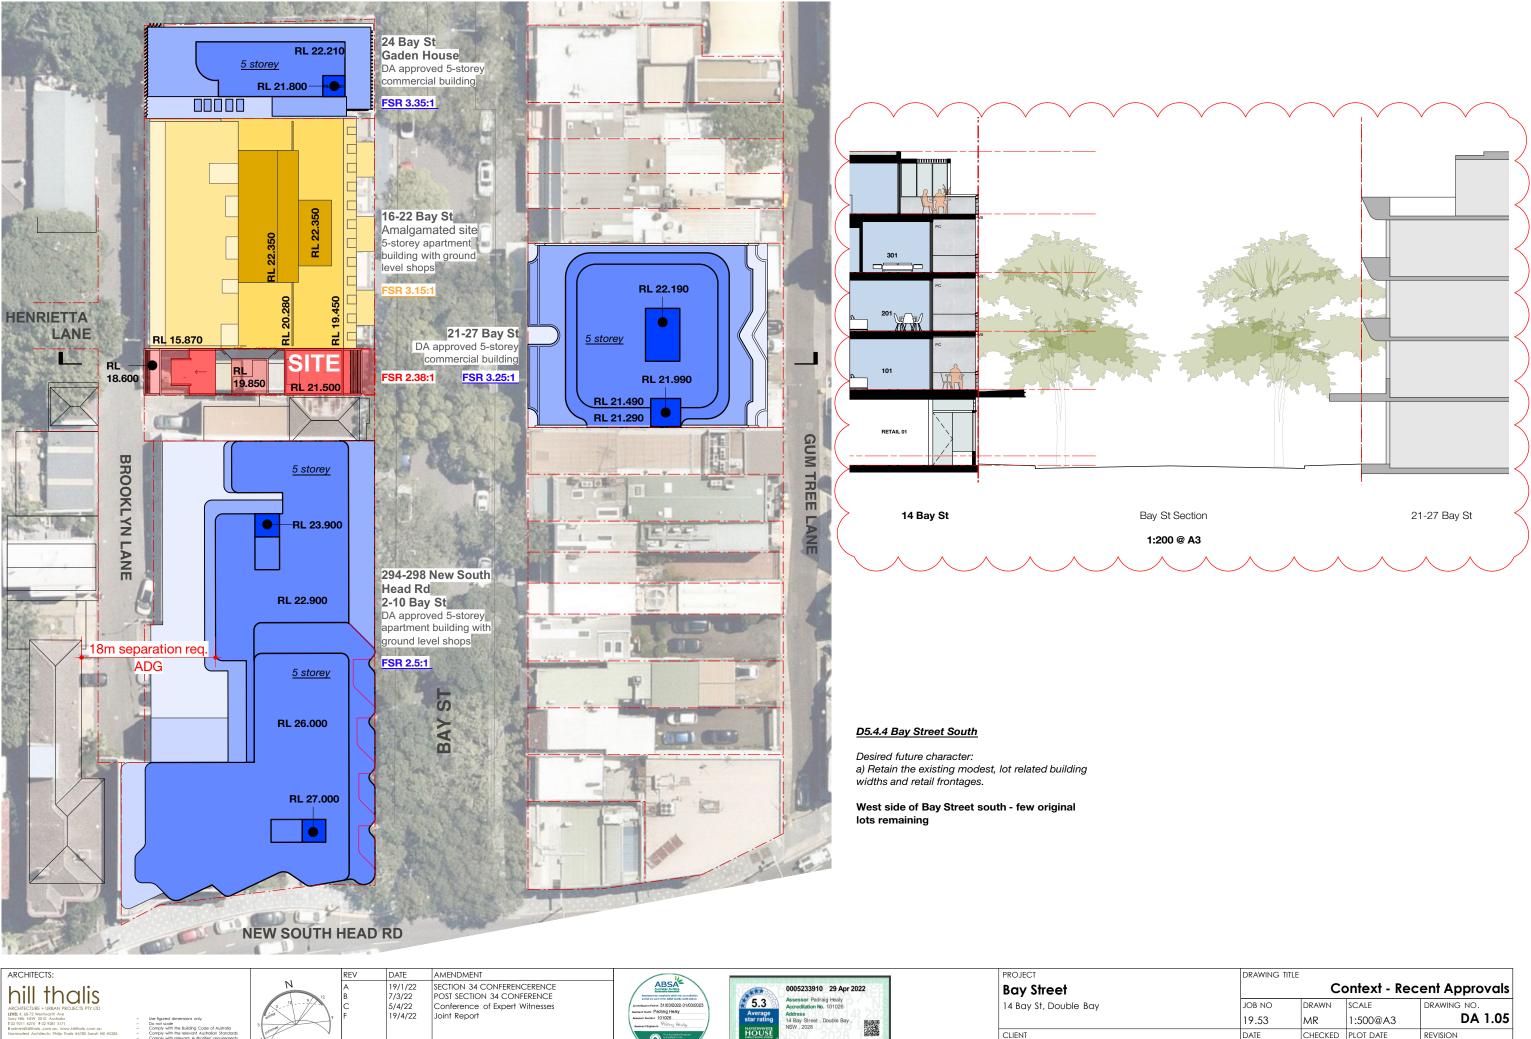


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DRAWING TITLE			
	Co	ontext - Rec	ent Approvals
JOB NO	DRAWN	SCALE	DRAWING NO.
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DATE	CHECKED	PLOT DATE	REVISION
Sept 2020	PT	19/4/22	F









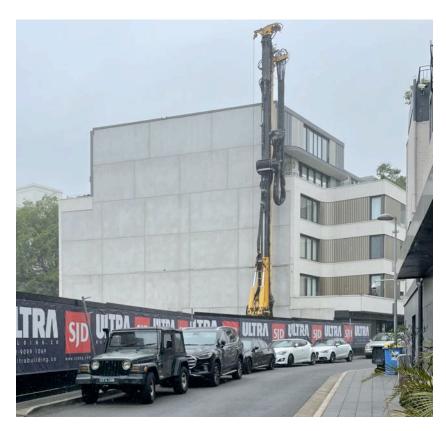



ARCHITECTS:		REV	DATE	AMENDMENT
hill thalis		A B F		SECTION 34 CONFERENCE Conference of Expert Witnesses Joint Report
LEVEL 4, 68-72 Wenhwath Ave Sumy Hill SWW 2010 Australia 1 02 9211 6276 F02 9281 3171 E admini@hillhasi.com.au E admini@hillhasi.com.au Nominated Architects: Philip Thats #6780 Sarah Hill #5285	Use figured dimensions only Do not scale Comply with the Building Code of Australia Comply with the relevant Australian Standards Comply with relevant Authorities' requirements			
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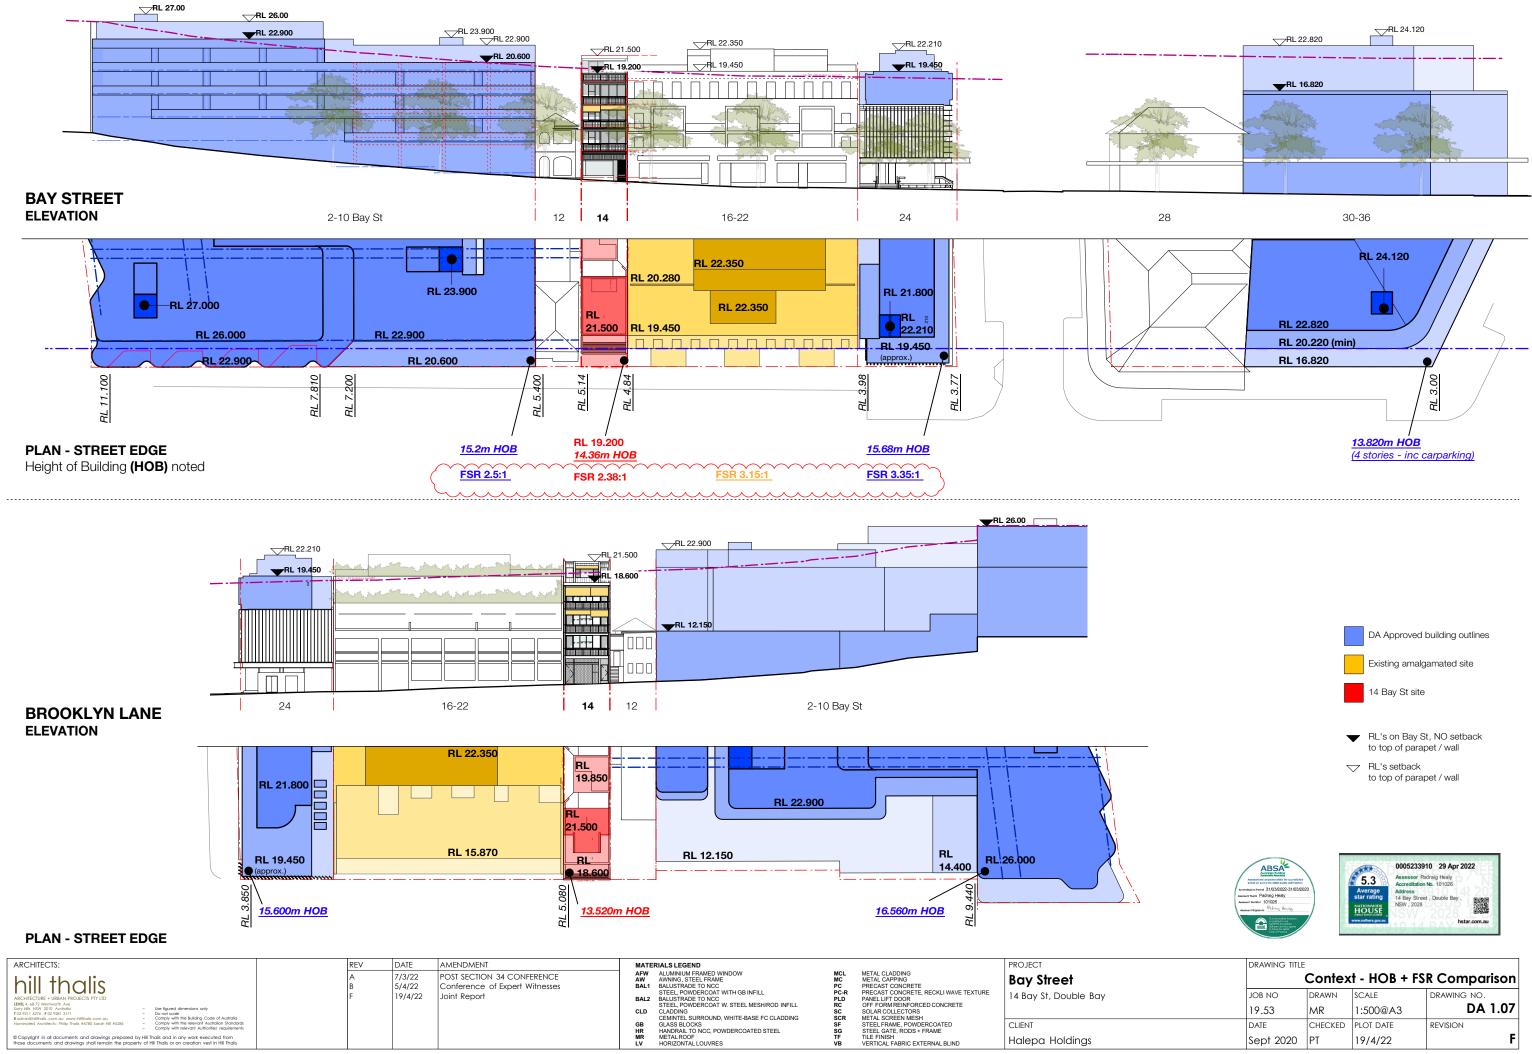
PROJECT Bay Street 14 Bay St, Double Bay

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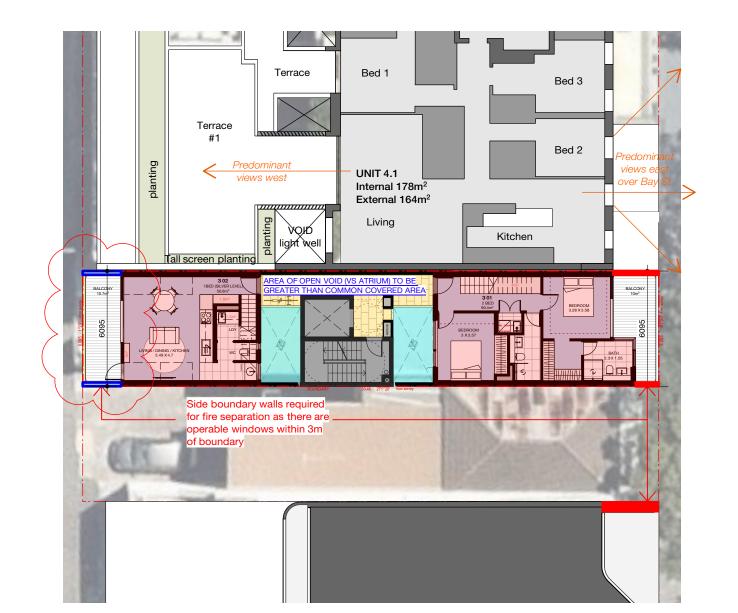





DRAWING TITLE	Conte	ext - Party W	all Conditions
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19.53	MR	NA	DA 1.06
DATE	CHECKED	PLOT DATE	REVISION
Sept 2020	PT	19/4/22	F



DRAWING TITLE			
	R Comparison		
JOB NO	DRAWN	SCALE	DRAWING NO.
19.53	MR	1:500@A3	DA 1.07
DATE	CHECKED	PLOT DATE	REVISION
Sept 2020	PT	19/4/22	F



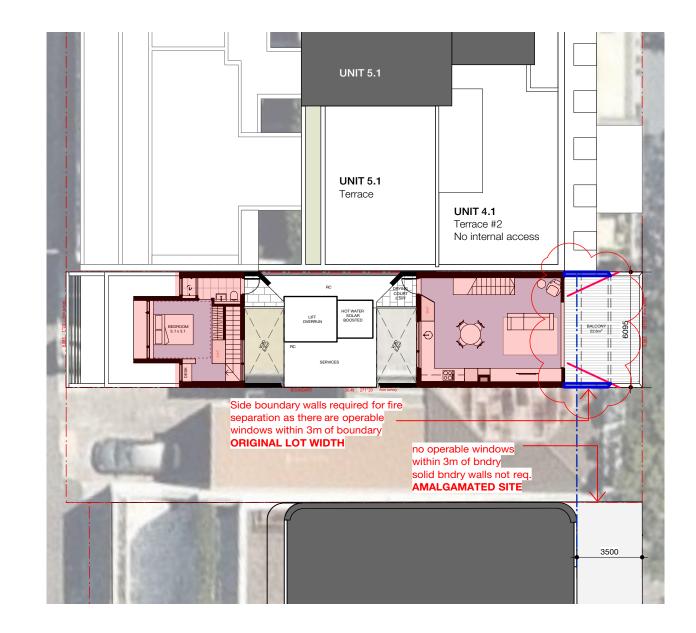



ARCHITECTS:

LEVEL 4, 68-72 Surry Hills NSV T 02 9211 627 E admin@hillt

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UNIT 4.1 Terrace # 1



UNIT 4.1 Terrace # 2





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DRAWING TITLE						
		Context - Unit 4.1 Terrace				
JOB NO	DRAWN	SCALE	DRAWING NO.			
19.53	MR	1:200@A3	DA 1.08			
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PROJECT
Bay Street
14 Bay St, Double Bay
CLIENT
Halepa Holdings

2.38:1 (2.46:1 previous)

DRAWING TITLE						
		R Calculations				
JOB NO	DRAWN	SCALE	DRAWING NO.			
19.53	MR	1:200@A3	DA 1.10			
DATE	CHECKED	PLOT DATE	REVISION			
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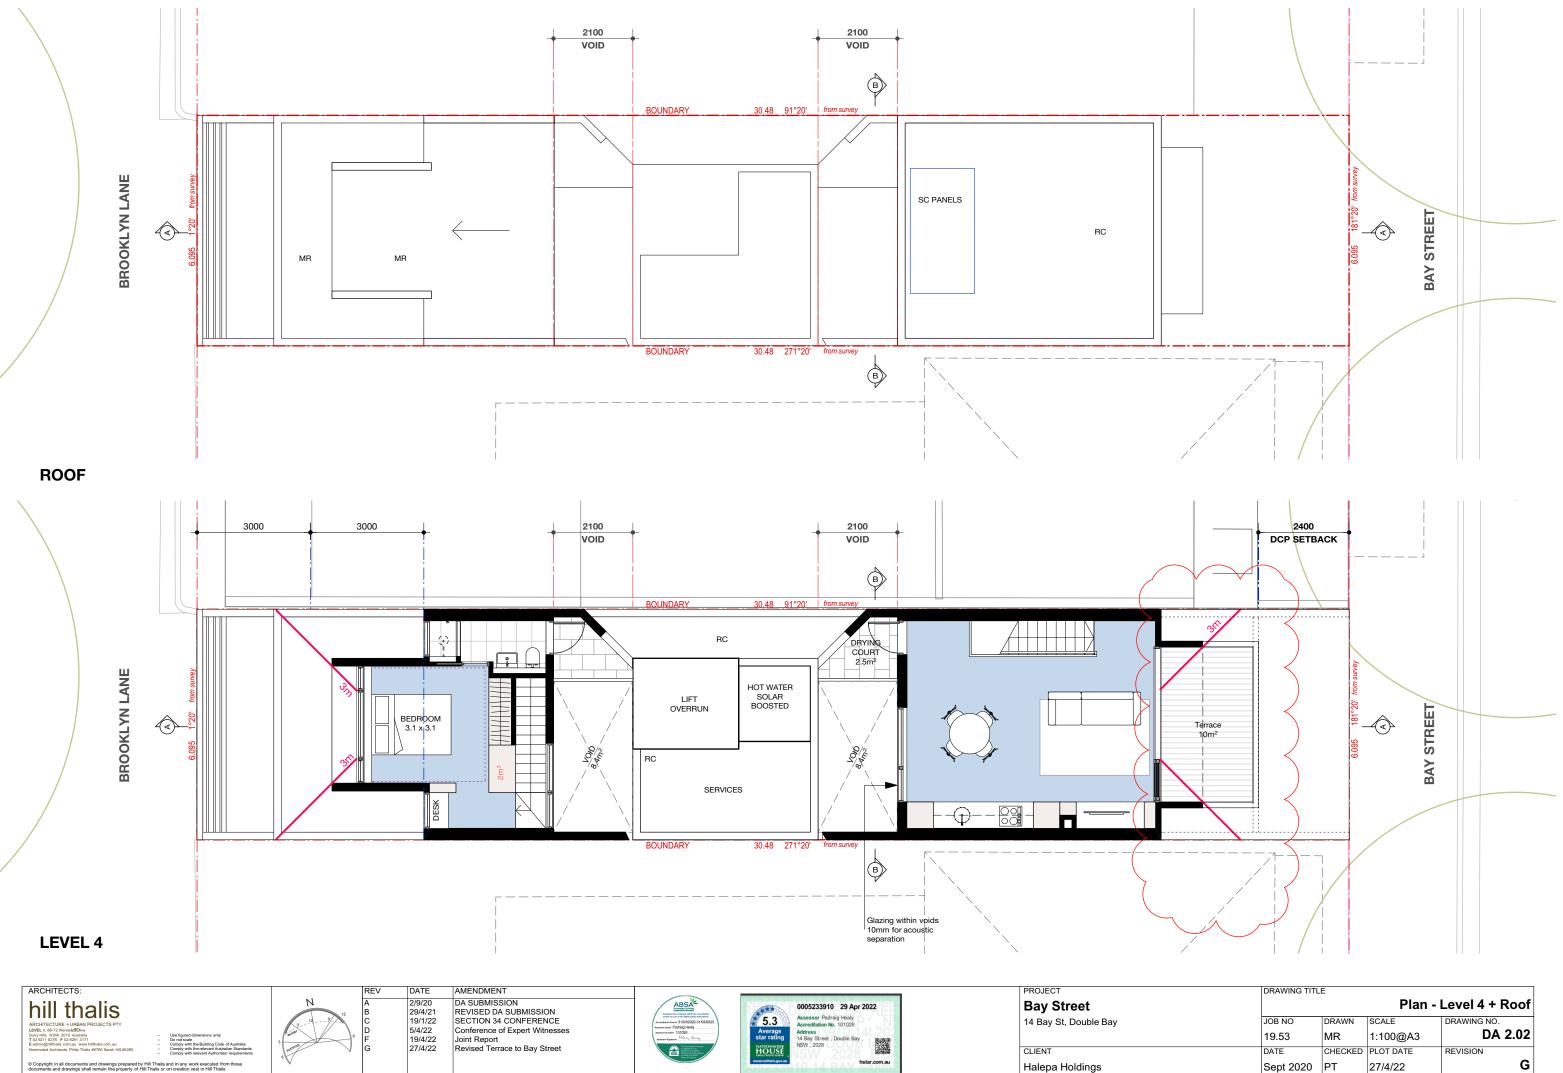


CLIENT Halepa Holdings

DRAWING TITLE			
	ound + Level 1		
JOB NO	DRAWN	SCALE	DRAWING NO.
19.53	MR	1:100@A3	DA 2.00
DATE	CHECKED	PLOT DATE	REVISION
Sept 2020	PT	19/4/22	F



DRAWING TITLE		n - Level 2 + 3	
JOB NO	DRAWN	SCALE	DRAWING NO.
19.53	MR	1:100@A3	DA 2.01
DATE	CHECKED	PLOT DATE	REVISION
Sept 2020	PT	19/4/22	F



DRAWING TITLI	Level 4 + Roof		
JOB NO	DRAWN	SCALE	DRAWING NO.
19.53	MR	1:100@A3	DA 2.02
DATE	CHECKED	PLOT DATE	REVISION
Sept 2020	PT	27/4/22	G



Sept 2020 PT

BAY STREET ELEVATION


Approved DA Parapet RL 22.90



BROOKLYN LANE ELEVATION




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		s - East + West			
JOB NO	DRAWN	SCALE	DRAWING NO.		
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DATE	CHECKED	PLOT DATE	REVISION		
Sept 2020	PT	27/4/22	G		

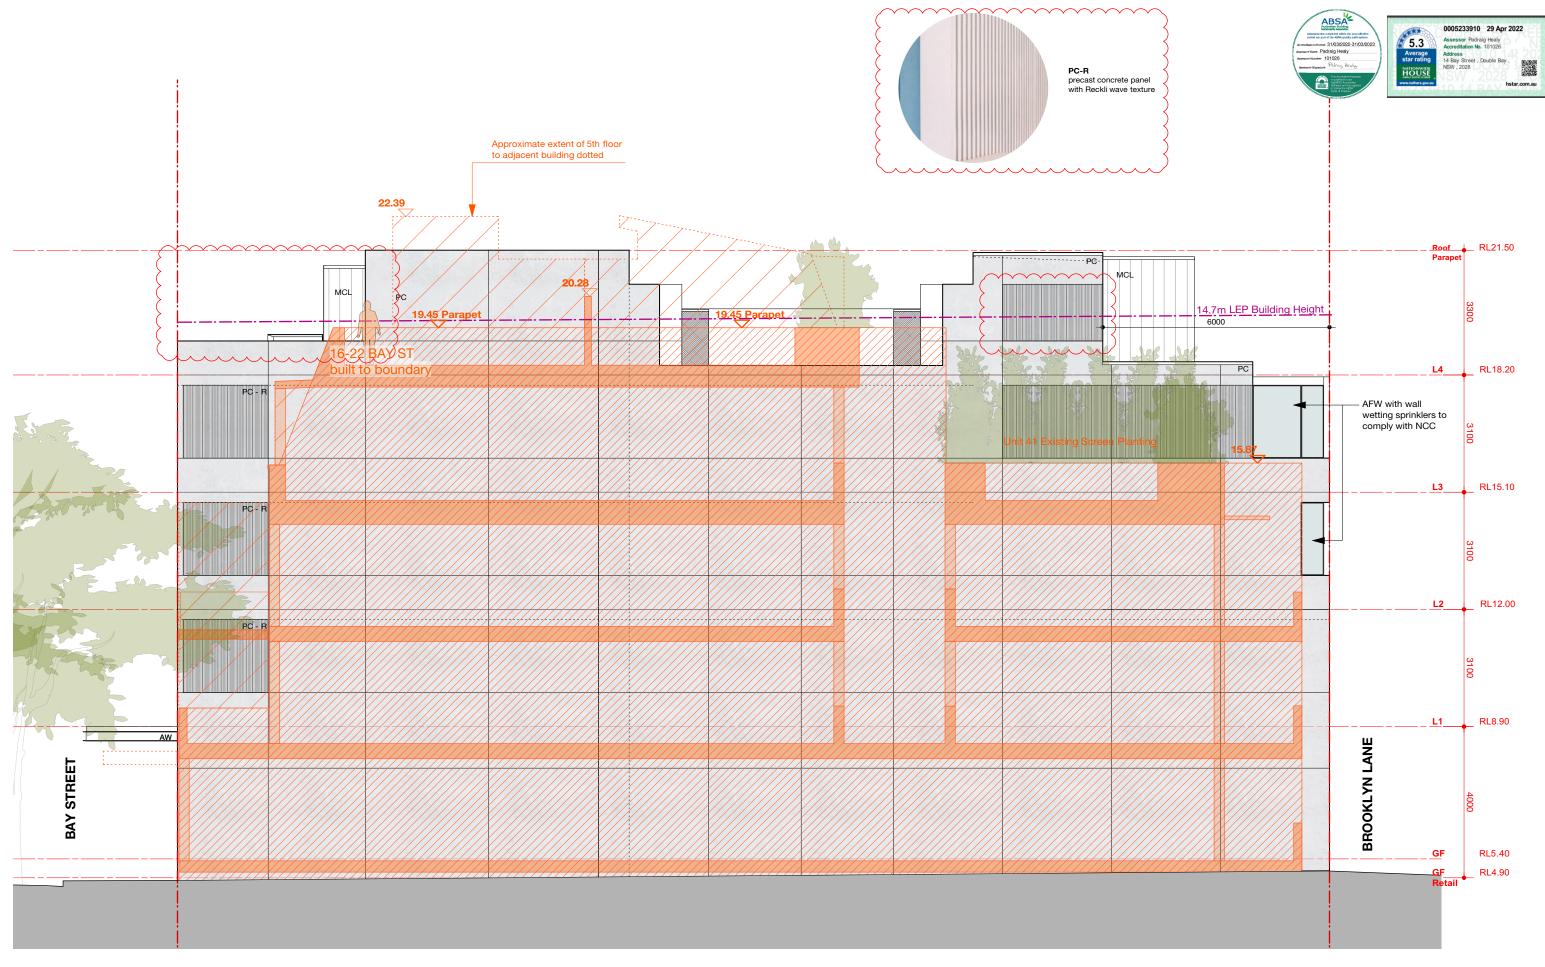

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Nominated Architects: Philip Thalis #6780 Sarah Hill #5285	Comply with the relevant Australian Standards Comply with relevant Authorities' requirements	G 2	27/4/22	Revised terrace to Bay Street	GB	GLASS BLOCKS HANDRAIL TO NCC, POWDERCOATED STEEL	SF	STEEL FRAME, POWDERCOATED STEEL GATE, RODS + FRAME	CLIENT
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DRAWING TITLI	vation - North		
JOB NO	DRAWN	SCALE	DRAWING NO.
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Sept 2020	PT	27/4/22	G

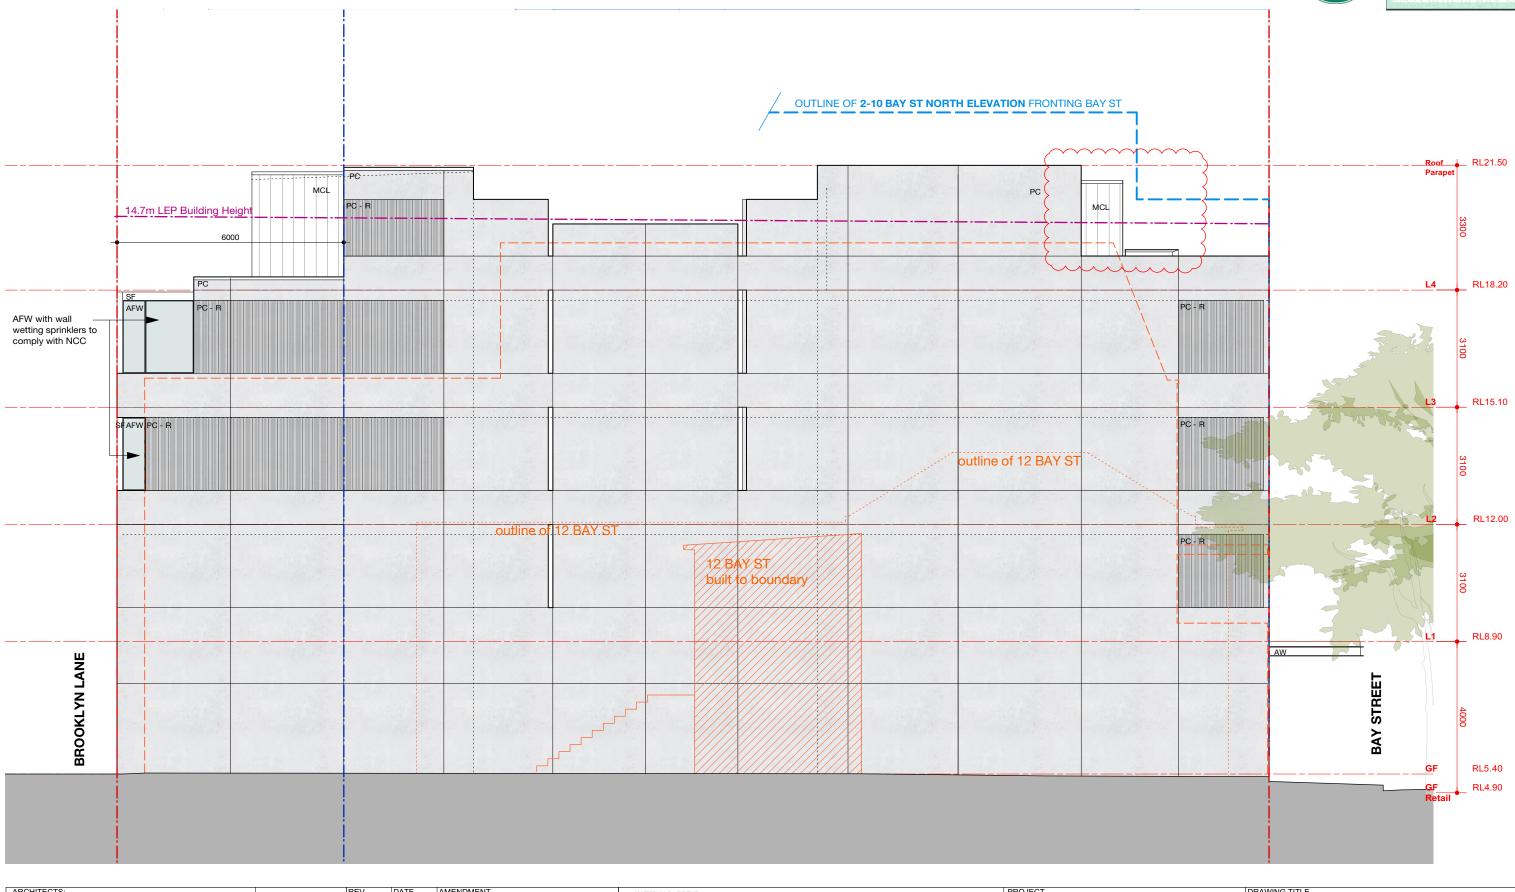

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hill thalis ARCHITECTURE + URBAN PROJECTS PTY LEVEL 4, 69, 2010 Australia Surry His NSW 2010 Australia Example This Association with History and Construction only E desting the Building Code of Australia	A B C D E	2/9/20 29/4/21 19/1/22 25/1/22 5/4/22	DA SUBMISSION REVISED DA SUBMISSION SECTION 34 CONFERENCE UPDATED SECTION 34 CONFERENCE Conference of Expert Witnesses	AFW AW AULMINIUM FRAMED WINDOW MCL MC METAL CLAPPING MC METAL CLAPPING Bay Bay BAL1 BALUSTRADE TO NCC PC PRECAST CONCRETE STEEL POWDERCOAT WITH GB INFILL PC-R PRECAST CONCRETE, RECKLI WAVE TEXTURE PLO TABLE SALUSTRADE TO NCC PL PAREL LIFT DOOR TABLE SALUSTRADE TO NCC TABLE SA
Neminated Architect: Philip Thails #8780 Sanah Hill #5285 - Comply with the relevant Automatics Standards - Comply with the relevant Automatics Standards - Comply with the relevant Automatics and drawings prepared by Hill Thails and in any work executed from those documents and drawings shall remain the property of Hill Thails or on creation vest in Hill Thails	F G	19/4/22 27/4/22	Joint Report Revised terrace to Bay Street	CEMINTEL SURROUND, WHITE-BASE FC CLADDING SCR METAL SCREEN MESH GB GLASS BLOCKS SF STEEL FRAME. POWDERCOATED SG STEEL GATE, RODS + FRAME HR HANDRAIL TO NCC, POWDERCOATED STEEL SGT E, RODS + FRAME MR METAL ROOF TF TILE FINISH LV HORZONTAL LOUVRES VB VERTICAL FABRIC EXTERNAL BLIND HAIPPA HOIDINGS






DRAWING TITLE Elevation - South					
JOB NO	DRAWN	SCALE	DRAWING NO.		
19.53	MR	1:100@A3	DA 3.03		
DATE	CHECKED	PLOT DATE	REVISION		
Sept 2020	PT	27/4/22	G		



DRAWING TITLE	E		Section A
JOB NO	DRAWN	SCALE	DRAWING NO.
19.53	MR	1:100@A3	DA 3.04
DATE	CHECKED	PLOT DATE	REVISION
Sept 2020	PT	27/4/22	G

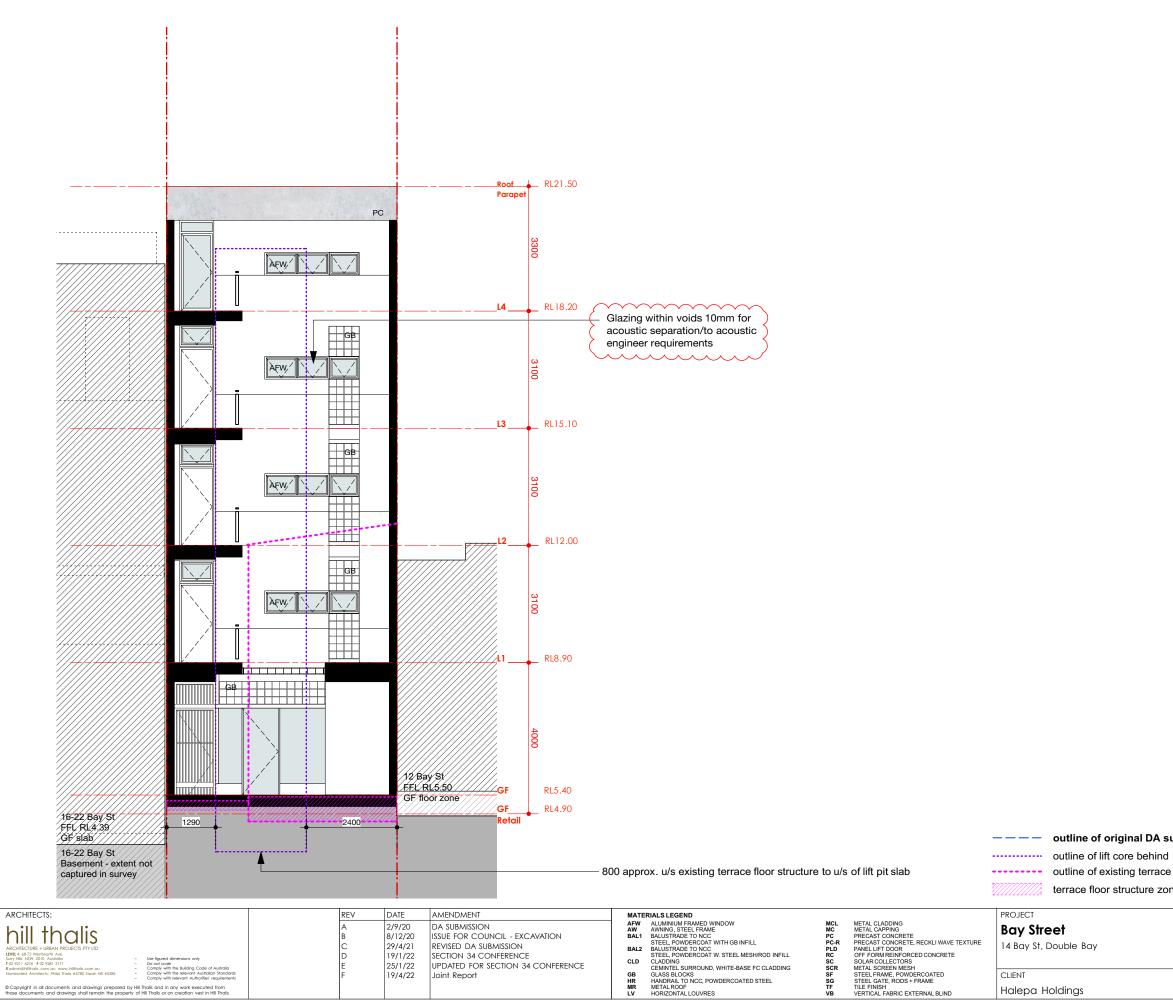





---- outline of original DA submission

outline of existing terrace and existing ground line

terrace floor structure zone

DRAWING TITLE			
			Section B
JOB NO	DRAWN	SCALE	DRAWING NO.
19.53	MR	1:100@A3	DA 3.05
DATE	CHECKED	PLOT DATE	REVISION
Sept 2020	PT	19/4/22	F



12 Henrietta St

14 Bay St

ARCHITECTS:	REV	DATE	AMENDMENT	MATERIALS LEGEND			PROJECT	DRAWING TIT	LE		
hill thalis	A F	19/1/22 19/4/22	SECTION 34 CONFERENCE Joint Report	AFW ALUMINIUM FRAMED WINDOW AW AWNING, STEEL FRAME BALL BALUSTRADE TO NCC	MCL MC PC	METAL CLADDING METAL CAPPING PRECAST CONCRETE	Bay Street			Sectio	n A - Extended
ARCHITECTURE + URBAN PROJECTS PTY	G	29/4/22	Revised terrace to Bay Street	STEEL, POWDERCOAT WITH GB INFILL BAL2 BALUSTRADE TO NCC	PC-R PLD	PRECAST CONCRETE, RECKLI WAVE TEXTURE PANEL LIFT DOOR	14 Bay St, Double Bay	JOB NO	DRAWN	SCALE	DRAWING NO.
LEVEL 4, 68-72 Worthwidt/Dure - Use figured dimensions only Sarry Hito. NWX 2010 Australia - Use figured dimensions only T 02 4211 6278 F02 4281 3171 - Do not scale E adminiphilitatios comu avwwhithaits comu av - Comply with the Building Code of Australia				CLADDING CLADDING CLADDING CEMINTEL SURROUND, WHITE-BASE FC CLADDING	RC SC	OFF FORM REINFORCED CONCRETE SOLAR COLLECTORS METAL SCREEN MESH		19.53	MR	1:100@A3	DA 3.06
Nominated Architects: Philip Thalis #6780 Sarah Hill #5285 - Comply with the relevant Australian Standards - Comply with relevant Australian Standards				GB GLASS BLOCKS	SF	STEEL FRAME, POWDERCOATED	CLIENT	DATE	CHECKED	PLOT DATE	REVISION
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21-27 Bay St DA approved 5-storey commercial building



Revised Proposal

NORTH ELEVATION

ARCHITECTS:	REV	DATE	AMENDMENT	MATERIALS LEGEND		PROJECT	DRAWING TITI	LE		
hill thalis	A	25/1/22	REQUESTED INFORMATION FOR \$34 CONFERENCE	AFW ALUMINIUM FRAMED WINDOW AW AWNING, STEEL FRAME BAL1 BALUSTRADE TO NCC	MCL METAL CLADDING MC METAL CAPPING PC PRECAST CONCRETE	Bay Street		Elev	ations - Cor	nparison page
ARCHITECTURE + URBAN PROJECTS PTY LID	F	19/4/22	Joint Report	STEEL, POWDERCOAT WITH GB INFILL BAL2 BALUSTRADE TO NCC	PC-R PRECAST CONCRETE, RECKLI WAVE TEXTURE PLD PANEL LIFT DOOR	14 Bay St, Double Bay	JOB NO	DRAWN	SCALE	DRAWING NO.
ARCHIECTURE + URBAN PROJECTS PTY LID LVPU 4. 637: Verhendin Ave Sury His KW 2010 Australia ExperimingPrint account of the second of the sec				STEEL, POWDERCOAT W. STEEL MESH/ROD INFILL CLD CLADDING CEMINTEL SURROUND. WHITE-BASE FC CLADDING	RC OFF FORM REINFORCED CONCRETE SC SOLAR COLLECTORS SCR METAL SCREEN MESH		19.53	MR	1:200@A3	DA 3.07
Comply with the relevant Australian Standards Comply with the relevant Australian Standards Comply with the relevant Australian Standards Comply with relevant Australian Standards				GB GLASS BLOCKS HR HANDRAIL TO NCC. POWDERCOATED STEEL	SF STEEL FRAME, POWDERCOATED SG STEEL GATE, RODS + FRAME	CLIENT	DATE	CHECKED	PLOT DATE	REVISION
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12 Bay St



external blinds on edge of balcony



concrete and FC cladding



steel frame balustrade, glass block infill



concrete, glass block




reflective inner core

ARCHITECTS:


ARCHITECTURE + URBAN LEVEL 4, 68-72 WentwårEDve Surry Hils NSW 2010 Australia T 02 9211 6276 F 02 9281 317 E admin@hillbalis.com.au www

hill thalis

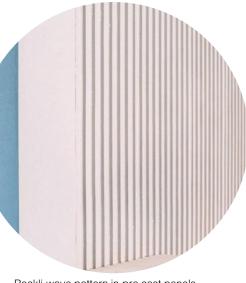

Reckli wave pattern in pre cast panels

BAL1	
VB	
AFW	AFW
BAL1	
AFW	AFW

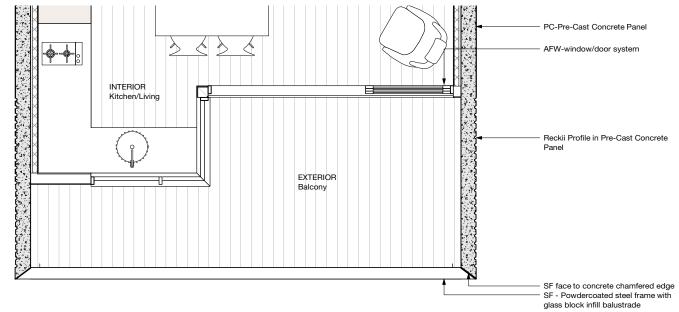


LEVEL 2 PLAN


REV	DATE	AMENDMENT	MATERIALS LEGEND			PROJECT	DRAWING TITI	E		
A B	2/9/20 25/1/22	DA SUBMISSION SECTION 34 CONFERENCE	AFW ALUMINIUM FRAMED WINDOW AW AWNING, STEEL FRAME BALL BALUSTRADE TO NCC	MCL MC PC	METAL CLADDING METAL CAPPING PRECAST CONCRETE	Bay Street		F	acade Deta	ils + Materiality
F	19/4/22	Joint Report	STEEL, POWDERCOAT WITH GB INFILL	PC-R	PRECAST CONCRETE, RECKLI WAVE TEXTURE	14 Bay St, Double Bay	JOB NO	DRAWN	SCALE	DRAWING NO.
G	29/4/22	Revised terrace to Bay Street	BAL2 BALUSTRADE TO NCC STEEL POWDERCOAT W. STEEL MESH/ROD INFILL CLADDING CEMINTEL SURROUND, WHITE-BASE FC CLADDING	PLD RC SC SCR	PANEL LIFT DOOR OFF FORM REINFORCED CONCRETE SOLAR COLLECTORS METAL SCREEN MESH	.,	19.53	MR	1:50@A3	DA 4.00
			GB GLASS BLOCKS	SF	STEEL FRAME, POWDERCOATED	CLIENT	DATE	CHECKED	PLOT DATE	REVISION
			HR HANDRAIL TO NCC, POWDERCOATED STEEL MR METAL ROOF LV HORIZONTAL LOUVRES	SG TF VB	STEEL GATE, RODS + FRAME TILE FINISH VERTICAL FABRIC EXTERNAL BLIND	Halepa Holdings	Sept 2020	PT	28/4/22	G

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Photomontage part of original DA submission Outline of revised proposal shown, approximate


ARCHITECTS:	REV	DATE	AMENDMENT	MATERIALS LEGEND			PROJECT
Anility Constraints Accurate a URDAN PROJECTS PTM Survive Name of the Straints Survive Survive Survive<	A F G	2/9/20 19/4/22 29/4/22	DA SUBMISSION Joint Report Revised terrace to Bay Street	AFW ALUMINUM FRAMED WINDOW AW AVMING, STEEL FRAME BALLI BALUSTRADE TO NCC STEEL, POWDERCOAT WITH GB INFILL BAL2 BALUSTRADE TO NCC CLD CLADDING CCEMINTEL SURROUND, WHITE-BASE FC CLADDING GB GLASS BLOCKS HR HANDRAIL TO NCC, POWDERCOATED STEEL MR METAL ROOF LV HORIZONTAL LOUVRES	MCL MC PC-R PLD RC SC SCR SF SG TF VB	METAL CLADDING METAL CAPPING PRECAST CONCRETE, RECKLI WAVE TEXTURE PAREL IFT DOOR OFF FORM REINFORCED CONCRETE SOLAR COLLECTORS METAL SCREEN MESH STEEL, GRAME, POWDERCOATED STEEL, GRAME, RODS + FRAME TUE FINISH VERTICAL FABRIC EXTERNAL BLIND	Bay Street 14 Bay St, Double Bay CLIENT Halepa Holdings

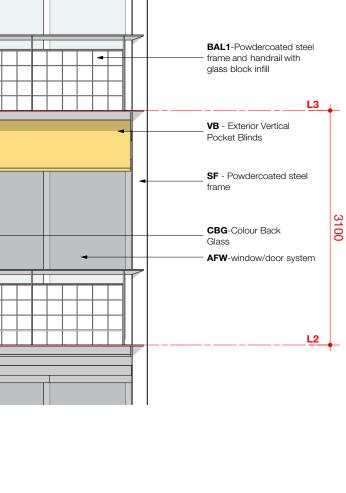

DRAWING TITLI	E	F	Photomontage
јов no 19.53	drawn MR	SCALE NTS	DRAWING NO. DA 4.01
DATE Sept 2020	CHECKED PT	PLOT DATE 28/4/22	

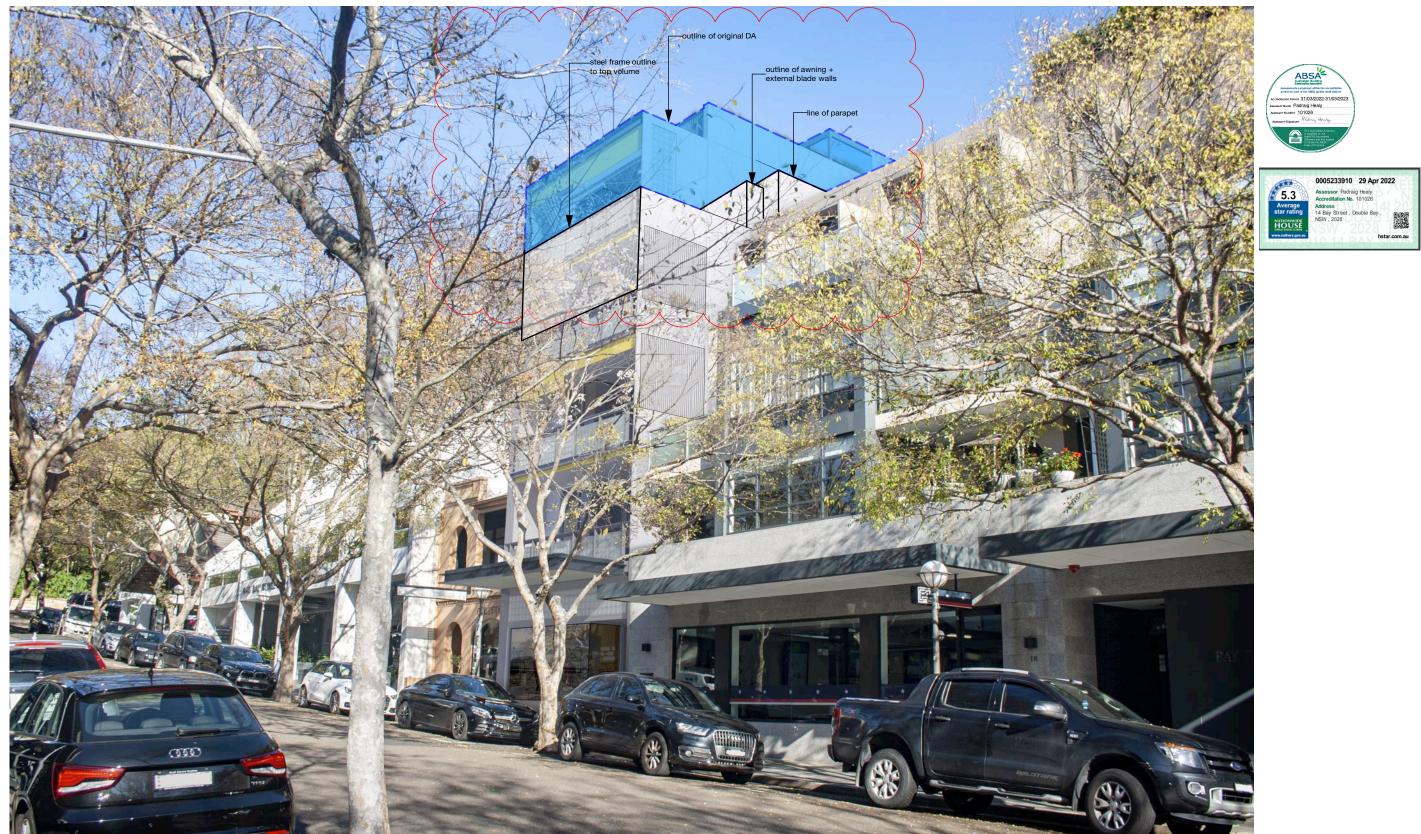EQUINOX

9AM

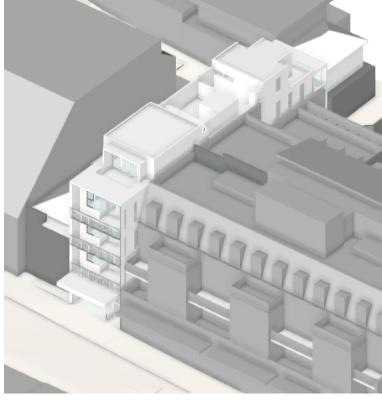



view from sun axonometric







shadows in plan existing (grey) + new <mark>(red)</mark>

ARCHITECTS:	REV	DATE	AMENDMENT	and the second second		PROJECT
hill thalis	A B	2/9/20 29/4/21	DA SUBMISSION REVISED DA SUBMISSION	Absolution the Address and second sec	0005233910 29 Apr 2022 Assessor Padraig Healy	Bay Street
ARCHTECTURE + URBAN PROJECTS PTY LEVEL 6.07 VentheRBVn Burry His NW 2010 Australia Use figured immensions only Examing White sonay ways hithdiscoma Comply with the Building Cost of Australia	G	28/4/22	Joint Report with Revised terrace to Bay Street	Accretitation Peniori 31/03/2022-31/03/2023. Austrator Name Padraig Healy Austrator Number 101026 Austrator Bigature Polikowy Houlige	Average Address star rating 14 Bay Street , Double Bay , Bay Market New 2028	14 Bay St, Double Bay
Nominated Architects: Philip Thails #0700 Sarah Hill #5285 Comply with the relevant Australian Standards Comply w				The Accession Addresse transmission of the Accession Source set is not made	NSW , 2028	CLIENT Halepa Holdings


12PM

3PM

DRAWING TITLE	ows - Equinox		
JOB NO	DRAWN	SCALE	DRAWING NO.
19.53		1:500@A3	DA 5.01
DATE	CHECKED	PLOT DATE	REVISION
		28/4/22	G

JUNE 21

9AM

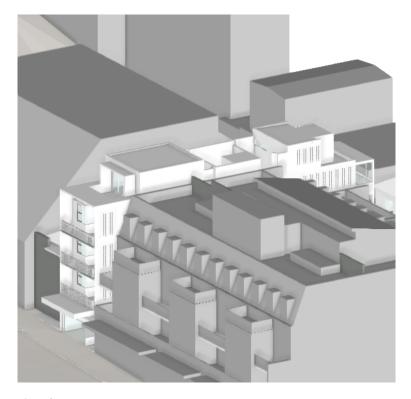




view from sun axonometric





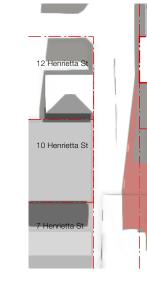

shadows in plan existing (grey) + new <mark>(red)</mark>

ARCHITECTS:	REV	DATE	AMENDMENT	and a state of the	005233910-14 RAY SI0052	PROJECT
Accurrecture UBAN PROJECTS PTV LEVEL 4.0 Vanchaflow - Survy Hits NSW 2010 Australia - - - Compared mensions only - - Compared mensions only - - Compared mensions only	A B F G	24/9/21 17/1/22 19/4/22 28/4/22	For Information Revised model to 10 Henrietta st Joint Report Revised Terrace to Bay Street	American Francisco Strategica Str	O005233910 29 Apr 2022 Sasessor Padraig Healy Accretation Ne. 101026 Adress Attrown Ne. 101026 Adress Nationwith Street, Double Bay, NSW, 2028	Bay Street 14 Bay St, Double Bay
E anning in rats contax of mix infrats contax in the second of the				Answertigerer	NSW, 2028	CLIENT Halepa Holdings

10AM


11AM



Hourly June 21 Shadows (Sheet 1)									
JOB NO	DRAWN	SCALE	DRAWING NO.						
19.53		1:500@A3	DA 5.02						
DATE	CHECKED	PLOT DATE	REVISION						
		28/4/22	G						

JUNE 21


12PM

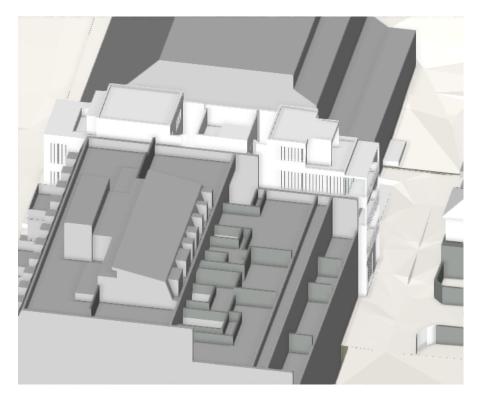


view from sun axonometric



shadows in plan existing (grey) + new <mark>(red)</mark> 1PM

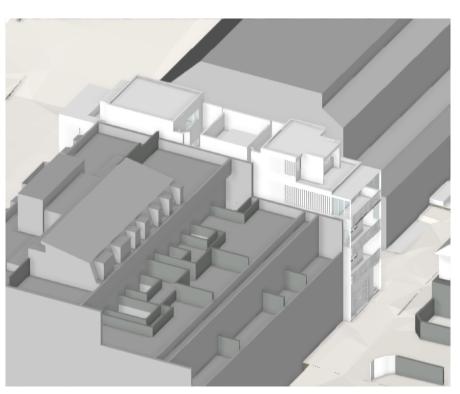

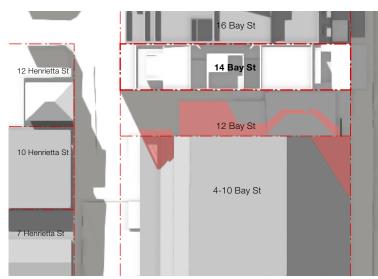


ARCHITECTS:	REV	DATE	AMENDMENT		05233010 17 RAV SI0057	PROJECT
Anili thalis Architecture + URBAN PROJECTS PTY Sury Hilk NEW 2010 Australia Sury Hilk NEW 2010 Australia Complexity Hild accorative with Hind accorative	A B F G	24/9/21 17/1/22 19/4/22 28/4/22	For Information Revised model to 10 Henrietta st Joint Report Revised Terrace to Bay Street	Amount Part of the Control of the Co	O005233910 29 Apr 2022 Sassor Padraig Healy Accreditation No. 101026 Address 14 Bay Street , Double Bay , NoW, 2028	Bay Street 14 Bay St, Double Bay
Nominated Architects: Philip Thails #6780 Sarah Hill #5285 - Comply with the relevant Australian Standards Copyly tight to all documents and drawings prepared by Hill Thails and in any work executed from those documents and drawings shall remain the property of Hill Thails or on creation vest in Hill Thails					Hot Luc See www.salders.gov.ee hstar.com.au	CLIENT Halepa Holdings



Hourly June 21 Shadows (Sheet 2)					
JOB NO	DRAWN	SCALE	DRAWING NO.		
19.53		1:500@A3	DA 5.03		
DATE	CHECKED	PLOT DATE	REVISION		
		28/4/22	G		

JUNE 21

2PM

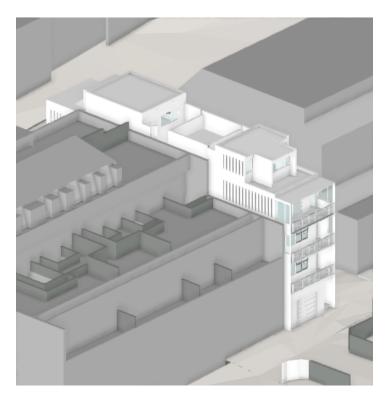

view from sun axonometric



shadows in plan existing (grey) + new <mark>(red)</mark> 3PM





ARCHITECTS:	REV	DATE	AMENDMENT	and the second s		PROJECT
hill thalis	AB	24/9/21 17/1/22	For Information Revised model to 10 Henrietta st	ABSA [®] Autorities Raching Autorities Resolution	0005233910 29 Apr 2022	Bay Street
ARCHITECTURE + URBAN PROJECTS PTY LVEL (6.87.2 WomhelfiDwe sury Hills NSW 2010 Australia T02 2011 2020 F C02 203 1011 On of scale zamingBitHitscom au www.hildhais.com au Comply with the Building Code of Australia	F G	19/4/22 28/4/22	Joint Report Revised Terrace to Bay Street	Accredition Parties 31(03/2022-31(03/2023) Accredition Parties 31(03/2022-31(03/2023) Accessor Numer Parties 101026 Accessor Numer 101026 Accessor Signature 95 Acoust Heally	5.3 Assessor Padraig Healy Accredition No. 101026 Address 14 Bay Street, Double Bay, NSW, 2028	14 Bay St, Double Bay
Nominated Architects: Philip Thalis #6780 Sarah Hill #5285 – Comply with the relevant Australian Standards – Comply with relevant Australian Standards – Comply with relevant Australian Standards					NOVV . ZUZU .L D/	CLIENT
© Copyright in all documents and drawings prepared by Hill Thalis and in any work executed from those documents and drawings shall remain the property of Hill Thalis or on creation vest in Hill Thalis				BOUEL	www.nathers.gov.au hold BAA hstar.com.au	Halepa Holdings



DRAWING TITLE Hourly June 21 Shadows (Sheet 3)					
JOB NO	DRAWN	SCALE	DRAWING NO.		
19.53		1:500@A3	DA 5.04		
DATE	CHECKED	PLOT DATE	REVISION		
		28/4/22	G		



Existing View





View with Outline of Proposed DA (14 Bay Street) and Approved DA (2-10 Bay Street)



Issue G - Revised terrace to Bay Street View SE from Eastern Terrace

DRAWING TITLE View Analysis 1 - Unit 4.1 Terrace East					
JOB NO	DRAWN	SCALE	DRAWING NO.		
19.53		NTS	DA 6.00		
DATE	CHECKED	PLOT DATE	REVISION		
		28/4/22	G		



Existing View



View with Outline of Proposed DA (14 Bay Street) and Approved DA (21-27 Bay Street)

ARCHITECTS:	REV D	DATE	AMENDMENT		005233010 14 BAY SI0057	PROJECT
Security Composition Acchitecture + URBAN PROJECTS PTI Level 4, 69,72 VersideHTMs Surger History - Marcines Surger History - Marcines Second History - Marcines Comply with the Building Code of Australia - Comply with the Building Code of Australia - Comply with the Building Code of Australia - Comply with the Building Code of Australia			Joint Report Revised terrace to Bay Street	Linear top 5 (SOCIES 2) (SOCIES 2	5.3 Average sar rgd Straft on Na. 101026 Address Ha By Straft, Double Bay. NSW, 2028	Bay Street 14 Bay St, Double Bay CLIENT
© Copyright in all documents and drawings prepared by Hill Thalis and in any work executed from those documents and drawings shall remain the property of Hill Thalis or on creation vest in Hill Thalis				E the state	0002000 14 DAY 510002	Halepa Holdings

DRAWING TITLE View Analysis 2 - Unit 4.1 Terrace East					
JOB NO	DRAWN	SCALE	DRAWING NO.		
19.53		NTS	DA 6.01		
DATE	CHECKED	PLOT DATE	REVISION		
		28/4/22	G		

Nationwide House Energy Rating Scheme — Class 2 summary NatHERS Certificate No. 0005233910

Generated on 29 Apr 2022 using BERS Pro v4.4.1.5 (3.21)

56

Property

Address 14 Bay Street , Double Bay , NSW , 2028

Lot/DP 18/4606

NatHERS climate zone

Accredited assessor

Padraig Healy Credwell Energy phealy@credwell.com.au 0498051209 Accreditation No. 101026 Assessor Accrediting Organisation



NATIONWIDE HOUSE ENERGY RATING SCHEME

R

The rating above is the average of all dwellings in this summary.

For more information on your dwelling's rating see: www.nathers.gov.au



Verification

To verify this certificate, scan the QR code or visit hstar.com.au/QR/Generate?p=iMqbXjXna . When using either link, ensure you are visiting hstar.com.au

Summary of all dwellings

Certificate number and link	Unit Number	Heating load (MJ/m ² /p.a.)	Cooling load (MJ/m ² /p.a.)	Total load (MJ/m ² /p.a.)	Star rating
0007677974	101	39.9	28.1	68	4.9
0007677982	102	41.9 494	24.1	66	4.9
0007678055	201	39.6	24.9	64.4	5.1
0007678063	202	40.1	24.4	64.6	5.1
0007678071-01	301	36.6	15, ZUZ	51.6	5.9

ABSA

Continued Over

National Construction Code (NCC) requirements

The NCC's requirements for NatHERS-rated buildings are detailed in 3.12.0(a)(i) and 3.12.5 of the NCC Volume Two. For apartments the requirements are detailed in J0.2 and J5 to J8 of the NCC Volume One.

In NCC 2019, these requirements include minimum star ratings and separate heating and cooling load limits that need to be met by buildings and apartments through the NatHERS assessment. Requirements additional to the NatHERS assessment that must also be satisfied include, but are not limited to: insulation installation methods, thermal breaks, building sealing, water heating and pumping, and artificial lighting requirements. The NCC and NatHERS Heating and Cooling Load Limits (Australian Building Codes Board Standard) are available at www.abcb.gov.au.

State and territory variations and additions to the NCC may also apply.



Summary of all dwellings (continued)

Certificate number and link	Unit Number	Heating load (MJ/m ² /p.a.)	Cooling load (MJ/m ² /p.a.)	Total load (MJ/m ² /p.a.)	Star rating
<u>0007678089</u>	302	39.4	16	55.4	5.7
Average		39.58	22.08	61.67	5.27

Explanatory Notes

About this report

This summary rating is the average rating of all NCC Class 2 dwellings in a development. The individual dwellings' ratings are a comprehensive, dynamic computer modelling evaluation of a home, using the floorplans, elevations and specifications to estimate the energy load. It addresses the building layout, orientation and fabric (i.e. walls, windows, floors, roofs and ceilings), but does not cover the water or energy use of appliances, or energy production of solar panels. For more details about an individual dwelling's assessment, refer to the individual dwelling's NatHERS Certificate (accessible via link).

Accredited Assessors

To ensure the NatHERS Certificate is of a high quality, always use an accredited or licenced assessor. NatHERS accredited assessors are members of a professional body called an Assessor Accrediting Organisation (AAO). AAOs have specific quality assurance processes in place, and continuing professional development requirements, to maintain a high and consistent standard of assessments across the country.

Any questions or concerns about this report should be directed to the assessor in the first instance. If the assessor is unable to address these questions or concerns, the AAO specified on the front of this certificate should be contacted.

Disclaimer

The format of the NatHERS Certificate was developed by the NatHERS Administrator. However the content, input and creation of the NatHERS Certificate is by the assessor. It is the responsibility of the assessor who prepared this certificate to use NatHERS accredited software correctly and follow the NatHERS Technical Notes to produce a NatHERS Certificate.

Energy Sect. J. JV3. BASIX. NABERS

BASIX Certificate Summary

ASSESSOR DETAILS	
Name:	Padraig Healy
Direct Number:	0498 051 209
Office:	(02) 9281 8555
AAO:	ABSA
Assessor Number:	101026
Project Name:	E20032
Software:	BERS Pro v4.4.1.5 (3.21)
Date:	29/04/2022
BASIX Certificate Number:	1129546M_02
Group Certificate Number:	0005233910
Client Name:	Maria Alis
Client Phone:	-
Client Email:	-

NCC COMPLIANCE

Building compliance is required to comply with the 'New South Wales Additions' in the NCC 2017- Volume 1.

- Building thermal construction in accordance with part J1.2
- If metal, framed sarking of R0.2 is required between stud and cladding as a thermal break
- Loss of ceiling insulation is compensated for by increased roof insulation in accordance with Part J1.3(c)
- Any roof lights, windows, doors and exhaust fans are sealed in accordance with Part J3
- Any new air-conditioning system is installed in accordance with Parts J5.2(a), J5.2(b), J5.2(c), J5.2(d), J5.2(f) & J5.2(g)
- Any new mechanical ventilation system is installed in accordance with Part J5.3.
- Any new miscellaneous exhaust system is installed in accordance with Part J5.4.
- Any new heated hot water system is installed in accordance with Part J7.2
- Any new energy monitoring equipment is installed in accordance with Part J8.3.

BASIX TECHNICAL NOTES – Defaults if not determined

- Medium coloured external walls
- Walls to common areas modelled as external with zero solar absorptance
- All ensuites are treated as conditioned
- Spaces without an openable window / door are included in the zone which they are accessed
- No mechanical heating or cooling appliances are modelled, including ceiling fans

NatHERS TECHNICAL NOTES – Defaults if not determined

- Models rated with no downlights
- Light coloured roof for temperate or cool climates
- Kitchens / wet areas tiled
- All other internal areas carpet
- Sealed vents to wet areas / laundry / kitchen
- Single story dwellings within 10m modelled as obstruction
- Double story dwellings within 20m modelled as obstruction
- Structures located at South are not modelled as obstruction



CREDWELL

Energy Sect. J. JV3. BASIX. NABERS

Energy Sect. J. JV3. BASIX. NABERS

BASIX Certificate Commitments:

Water	Pass - 40%
Rainwater Tank:	1000L
Landscape connection:	Yes
Water Taps:	6-stars
Showerheads:	3-stars (4.5-6 L/min)
Toilet Flusher:	4-stars
Dishwasher:	5-star dishwasher

Thermal Comfort	Pass - 5.5 Star Overall Average	Pass - 5.5 Star Overall Average					
	Fixed/Sliding Glazing	Awning/Bi-Fold					
	Units: 301	Units: 301					
Glazing:	Thermal Specs: U-value 4.3 & SHGC 0.53 (+/- 10%)	Thermal Specs: U-value 4.3 & SHGC 0.47 (+/- 10%)					
	Units: All other units	Units: All other units					
	Thermal Specs: U-value 5.4 & SHGC 0.58 (+/- 10%)	Thermal Specs: U-value 5.4 & SHGC 0.49 (+/- 10%)					
External Walls:	Type: Concrete	Insulation: R2.5 bulk insulation					
Internal Walls:	Type: Stud	Insulation: Nil					
Ceiling Cavity:	Type: Plasterboard	Insulation: R4.0 bulk insulation					
Exposed Roof:	Type: Concrete	Insulation: Nil					

Energy	Pass - 35%	
Common Areas:	Lighting	LED's throughout with motion sensors
	Lifts	VVVF motor
	Ventilation	Exhaust only to Acc WC and bin store
	Hot Water	Solar – electric boosted (5m2 solar collector)
Dwellings:	Heating/Cooling	Ceiling fans only to living rooms
	Lighting	-
	Ventilation	Laundry & WC fan ducted to façade and interlocked to light Kitchen fan ducted to façade with manual switch
	Appliances	Electric cooktop & electric oven; 3-star dishwashers 2-stars dryers
	Fridge Space	Well ventilated
	Photovoltaics	3.1 peak kW's

BASIX[°]Certificate

Building Sustainability Index www.basix.nsw.gov.au

Multi Dwelling

Certificate number: 1129546M_02

This certificate confirms that the proposed development will meet the NSW government's requirements for sustainability, if it is built in accordance with the commitments set out below. Terms used in this certificate, or in the commitments, have the meaning given by the document entitled "BASIX Definitions" dated 10/09/2020 published by the Department. This document is available at www.basix.nsw.gov.au

This certificate is a revision of certificate number 1129546M lodged with the consent authority or certifier on 05 November 2020 with application 449/2020.

It is the responsibility of the applicant to verify with the consent authority that the original, or any revised certificate, complies with the requirements of Schedule 1 Clause 2A, 4A or 6A of the Environmental Planning and Assessment Regulation 2000

Secretary

Date of issue: Friday, 29 April 2022 To be valid, this certificate must be lodged within 3 months of the date of issue.



Planning, Industry & Environment

Project summary			
Project name	E20032-14 Bay Street_02		
Street address	14 Bay Street Double Bay 2028		
Local Government Area	Woollahra Municipal Council		
Plan type and plan number	deposited 4606		
Lot no.	18		
Section no.	-		
No. of residential flat buildings	1		
No. of units in residential flat buildings	6		
No. of multi-dwelling houses	0		
No. of single dwelling houses	0		
Project score			
Water	V 40 Target 40		
Thermal Comfort	V Pass Target Pass		
Energy	V 35 Target 35		

Certificate Prepared by	
Name / Company Name: Credwell Energy	
ABN (if applicable): 625598352	

Description of project

Project address

E20032-14 Bay Street_02	
14 Bay Street Double Bay 2028	
Woollahra Municipal Council	
deposited 4606	
18	
-	
1	
6	
0	
0	
183.4	
100	
47.0	
0	
0	

Common area landscape			
Common area lawn (m²)	0.0		
Common area garden (m²)	12.0		
Area of indigenous or low water use species (m ²)	8.4		
Assessor details			
Assessor number	101056		
Certificate number	0005233910		
Climate zone	56		
Ceiling fan in at least one bedroom	No		
Ceiling fan in at least one living room or other conditioned area	No		
Project score			
Water	40	Target 40	
Thermal Comfort	V Pass	Target Pass	
Energy	V 35	Target 35	

Description of project

The tables below describe the dwellings and common areas within the project

Residential flat buildings - Building1, 6 dwellings, 5 storeys above ground

	Dwelling no.	No. of hedrooms	Conditioned floor area (m²)	Unconditioned floor area (m²)	Area of garden & lawn (m²)	Indigenous species (min area m²)	Dwelling no.	No. of hedrooms	Conditioned floor area (m²)	Unconditioned floor area (m²)	Area of garden & lawn (m²)	lin g	Dwelling no.	No. of hedrooms	Conditioned floor area (m²)	Unconditioned floor area (m²)	Area of garden & lawn (m²)	Indigenous species (min area m²)	Dwelling no.	No. of bedrooms	Conditioned floor area (m²)	Unconditioned floor area (m²)	Area of garden & lawn (m²)	Indigenous species (min area m²)	Dwelling no.	No. of bedrooms	Conditioned floor area (m²)	Unconditioned floor area (m²)	Area of garden & lawn (m²)	Indigenous species (min area m²)
	101	1	52.0	0.0	0.0	0.0	102	1	40.8	0.0	0.0	0.0	201	1	52.0	0.0	0.0	0.0	202	1	40.8	0.0	0.0	0.0	301	2	90.4	0.0	0.0	0.0
;	302	1	54.8	2.0	0.0	0.0													<u>. </u>											

Description of project

The tables below describe the dwellings and common areas within the project

Common areas of unit building - Building1

Common area	Floor area (m ²)	Common area	Floor area (m²)	Common area	Floor area (m²)
Loading Zone	31.0	Lift car (No.1)	-	ACC WC	5.9
BIN Store	10.6	Services	3.77	Entry & hallways	110.0
FS (All levels)	29.1				

Schedule of BASIX commitments

1. Commitments for Residential flat buildings - Building1

(a) Dwellings

(i) Water

(ii) Energy

(iii) Thermal Comfort

(b) Common areas and central systems/facilities

(i) Water

(ii) Energy

2. Commitments for multi-dwelling houses

3. Commitments for single dwelling houses

4. Commitments for common areas and central systems/facilities for the development (non-building specific)

(i) Water

(ii) Energy

Schedule of BASIX commitments

The commitments set out below regulate how the proposed development is to be carried out. It is a condition of any development consent granted, or complying development certificate issued, for the proposed development, that BASIX commitments be complied with.

1. Commitments for Residential flat buildings - Building1

(a) Dwellings

(i) Water	Show on DA plans	Show on CC/CDC plans & specs	Certifier check
(a) The applicant must comply with the commitments listed below in carrying out the development of a dwelling listed in a table below.			
(b) The applicant must plant indigenous or low water use species of vegetation throughout the area of land specified for the dwelling in the "Indigenous species" column of the table below, as private landscaping for that dwelling. (This area of indigenous vegetation is to be contained within the "Area of garden and lawn" for the dwelling specified in the "Description of Project" table).	~	~	
(c) If a rating is specified in the table below for a fixture or appliance to be installed in the dwelling, the applicant must ensure that each such fixture and appliance meets the rating specified for it.		 	~
(d) The applicant must install an on demand hot water recirculation system which regulates all hot water use throughout the dwelling, where indicated for a dwelling in the "HW recirculation or diversion" column of the table below.		 	~
(e) The applicant must install:			
(aa) a hot water diversion system to all showers, kitchen sinks and all basins in the dwelling, where indicated for a dwelling in the "HW recirculation or diversion" column of the table below; and		~	~
(bb) a separate diversion tank (or tanks) connected to the hot water diversion systems of at least 100 litres. The applicant must connect the hot water diversion tank to all toilets in the dwelling.		 Image: A second s	~
(e) The applicant must not install a private swimming pool or spa for the dwelling, with a volume exceeding that specified for it in the table below.	~	 	
(f) If specified in the table, that pool or spa (or both) must have a pool cover or shading (or both).		~	
(g) The pool or spa must be located as specified in the table.	~	~	
(h) The applicant must install, for the dwelling, each alternative water supply system, with the specified size, listed for that dwelling in the table below. Each system must be configured to collect run-off from the areas specified (excluding any area which supplies any other alternative water supply system), and to divert overflow as specified. Each system must be connected as specified.	~	~	~

Fixtures						Appli	Individual pool				Individual spa			
Dwelling no.	All shower- heads	All toilet flushing systems	All kitchen taps	All bathroom taps	HW recirculation or diversion	All clothes washers	All dish- washers	Volume (max volume)	Pool cover	Pool location	Pool shaded	Volume (max volume)	Spa cover	Spa shaded
All dwellings	3 star (> 4.5 but <= 6 L/min)	4 star	6 star	6 star	no	-	5 star	-	-	-	-	-	-	-

			Alternative water sou	rce				
Dwelling no.	Alternative water supply systems	Size	Configuration	Landscape connection	Toilet connection (s)	Laundry connection	Pool top-up	Spa top-up
None	-	-	-	-	-	-	-	-

(ii) Energy	Show on DA plans	Show on CC/CDC plans & specs	Certifier check
(a) The applicant must comply with the commitments listed below in carrying out the development of a dwelling listed in a table below.			
(b) The applicant must install each hot water system specified for the dwelling in the table below, so that the dwelling's hot water is supplied by that system. If the table specifies a central hot water system for the dwelling, then the applicant must connect that central system to the dwelling, so that the dwelling's hot water is supplied by that central system.	~	~	~
(c) The applicant must install, in each bathroom, kitchen and laundry of the dwelling, the ventilation system specified for that room in the table below. Each such ventilation system must have the operation control specified for it in the table.		~	~
(d) The applicant must install the cooling and heating system/s specified for the dwelling under the "Living areas" and "Bedroom areas" headings of the "Cooling" and "Heating" columns in the table below, in/for at least 1 living/bedroom area of the dwelling. If no cooling or heating system is specified in the table for "Living areas" or "Bedroom areas", then no systems may be installed in any such areas. If the term "zoned" is specified beside an air conditioning system, then the system must provide for day/night zoning between living areas and bedrooms.		~	~
(e) This commitment applies to each room or area of the dwelling which is referred to in a heading to the "Artificial lighting" column of the table below (but only to the extent specified for that room or area). The applicant must ensure that the "primary type of artificial lighting" for each such room in the dwelling is fluorescent lighting or light emitting diode (LED) lighting. If the term "dedicated" is specified for a particular room or area, then the light fittings in that room or area must only be capable of being used for fluorescent lighting or light emitting diode (LED) lighting.		~	~

ii) Energy	Show on DA plans	Show on CC/CDC plans & specs	Certifier check
(f) This commitment applies to each room or area of the dwelling which is referred to in a heading to the "Natural lighting" column of the table below (but only to the extent specified for that room or area). The applicant must ensure that each such room or area is fitted with a window and/or skylight.	~	~	~
(g) This commitment applies if the applicant installs a water heating system for the dwelling's pool or spa. The applicant must:			
(aa) install the system specified for the pool in the "Individual Pool" column of the table below (or alternatively must not install any system for the pool). If specified, the applicant must install a timer, to control the pool's pump; and		~	
(bb) install the system specified for the spa in the "Individual Spa" column of the table below (or alternatively must not install any system for the spa). If specified, the applicant must install a timer to control the spa's pump.		~	
(h) The applicant must install in the dwelling:			
(aa) the kitchen cook-top and oven specified for that dwelling in the "Appliances & other efficiency measures" column of the table below;		~	
(bb) each appliance for which a rating is specified for that dwelling in the "Appliances & other efficiency measures" column of the table, and ensure that the appliance has that minimum rating; and		~	~
(cc) any clothes drying line specified for the dwelling in the "Appliances & other efficiency measures" column of the table.		~	
(i) If specified in the table, the applicant must carry out the development so that each refrigerator space in the dwelling is "well ventilated".		~	

	Hot water	Bathroom ven	tilation system	Kitchen venti	lation system	Laundry ventilation system		
Dwelling no.	Hot water system	Each bathroom	Operation control	Each kitchen	Operation control	Each laundry	Operation control	
All dwellings	central hot water system 1	individual fan, ducted to façade or roof	manual switch on/off	individual fan, ducted to façade or roof	manual switch on/off	individual fan, ducted to façade or roof	manual switch on/off	

	Cooling		Heating				Natural lighting					
Dwelling no.	living areas	bedroom areas	living areas	bedroom areas	No. of bedrooms &/or study	No. of living &/or dining rooms	Each kitchen	All bathrooms/ toilets	Each Iaundry	All hallways	No. of bathrooms &/or toilets	Main kitch
101, 201, 301	ceiling fans	ceiling fans	-	-	1 (dedicated)	1 (dedicated)	yes (dedicated)	yes (dedicated)	yes (dedicated)	yes (dedicated)	0	yes
All other dwellings	ceiling fans	ceiling fans	-	-	1 (dedicated)	1 (dedicated)	yes (dedicated)	yes (dedicated)	yes (dedicated)	yes (dedicated)	1	no

	Individual pool		Individual spa		Appliances & other efficiency measures									
Dwelling no.	Pool heating system	Timer	Spa heating system	Timer	Kitchen cooktop/oven	Refrigerator	Well ventilated fridge space	Dishwasher	Clothes washer	Clothes dryer	Indoor or sheltered clothes drying line	Private outdoor or unsheltered clothes drying line		
All dwellings	-	-	-	-	electric cooktop & electric oven	-	yes	3 star	-	2 star	no	no		

(iii) Thermal Comfort	Show on DA plans	Show on CC/CDC plans & specs	Certifier check
(a) The applicant must attach the certificate referred to under "Assessor details" on the front page of this BASIX certificate (the "Assessor Certificate") to the development application and construction certificate application for the proposed development (or, if the applicant is applying for a complying development certificate for the proposed development, to that application). The applicant must also attach the Assessor Certificate to the application for a final occupation certificate for the proposed development.			
(b) The Assessor Certificate must have been issued by an Accredited Assessor in accordance with the Thermal Comfort Protocol.			
(c) The details of the proposed development on the Assessor Certificate must be consistent with the details shown in this BASIX Certificate, including the details shown in the "Thermal Loads" table below.			
(d) The applicant must show on the plans accompanying the development application for the proposed development, all matters which the Thermal Comfort Protocol requires to be shown on those plans. Those plans must bear a stamp of endorsement from the Accredited Assessor, to certify that this is the case.	~		

iii) Thermal Comfort	Show on DA plans	Show on CC/CDC plans & specs	Certifier check
(e) The applicant must show on the plans accompanying the application for a construction certificate (or complying development certificate, if applicable), all thermal performance specifications set out in the Assessor Certificate, and all aspects of the proposed development which were used to calculate those specifications.		~	
(f) The applicant must construct the development in accordance with all thermal performance specifications set out in the Assessor Certificate, and in accordance with those aspects of the development application or application for a complying development certificate which were used to calculate those specifications.		~	~
(g) Where there is an in-slab heating or cooling system, the applicant must:	~	~	~
(aa) Install insulation with an R-value of not less than 1.0 around the vertical edges of the perimeter of the slab; or			
(bb) On a suspended floor, install insulation with an R-value of not less than 1.0 underneath the slab and around the vertical edges of the perimeter of the slab.			
(h) The applicant must construct the floors and walls of the development in accordance with the specifications listed in the table below.	~	~	~

		Thermal loads			
Dwelling no.	Area adjusted heating load (in mJ/m²/yr)	Area adjusted cooling load (in mJ/m²/yr)			
101	39.9	28.1			
102	41.9	24.1			
201	39.6	24.9			
202	40.1	24.4			
301	36.6	15.0			
All other dwellings	39.4	16.0			

(b) Common areas and central systems/facilities

(i) Water	Show on DA plans	Show on CC/CDC plans & specs	Certifier check
(a) If, in carrying out the development, the applicant installs a showerhead, toilet, tap or clothes washer into a common area, then that item must meet the specifications listed for it in the table.		~	~
(b) The applicant must install (or ensure that the development is serviced by) the alternative water supply system(s) specified in the "Central systems" column of the table below. In each case, the system must be sized, be configured, and be connected, as specified in the table.	~	~	~
(c) A swimming pool or spa listed in the table must not have a volume (in kLs) greater than that specified for the pool or spa in the table.	~	~	
(d) A pool or spa listed in the table must have a cover or shading if specified for the pool or spa in the table.		~	
(e) The applicant must install each fire sprinkler system listed in the table so that the system is configured as specified in the table.		~	~
(f) The applicant must ensure that the central cooling system for a cooling tower is configured as specified in the table.		~	~

Common area	Showerheads rating	Toilets rating	Taps rating	Clothes washers rating
All common areas	no common facility	4 star	6 star	no common laundry facility

Central systems	Size	Configuration	Connection (to allow for)
Central water tank - rainwater or stormwater (No. 1)	1000.0	To collect run-off from at least: - 50.0 square metres of roof area of buildings in the development	 irrigation of 12.0 square metres of common landscaped area on the site car washing in 0 car washing bays on the site
Fire sprinkler system (No. 1)	-	-	-

(ii) Energy	Show on DA plans	Show on CC/CDC plans & specs	Certifier check
(a) If, in carrying out the development, the applicant installs a ventilation system to service a common area specified in the table below, then that ventilation system must be of the type specified for that common area, and must meet the efficiency measure specified.		~	~

(ii) Energy	Show on DA plans	Show on CC/CDC plans & specs	Certifier check
(b) In carrying out the development, the applicant must install, as the "primary type of artificial lighting" for each common area specified in the table below, the lighting specified for that common area. This lighting must meet the efficiency measure specified. The applicant must also install a centralised lighting control system or Building Management System (BMS) for the common area, where specified.		~	~
(c) The applicant must install the systems and fixtures specified in the "Central energy systems" column of the table below. In each case, the system or fixture must be of the type, and meet the specifications, listed for it in the table.	~	 	~

	Common area v	entilation system		Common area lighting	ghting	
Common area	Ventilation system type	Ventilation efficiency measure	Primary type of artificial lighting	Lighting efficiency measure	Lighting control system/BMS	
Loading Zone	no mechanical ventilation	-	light-emitting diode	motion sensors	No	
Lift car (No.1)	-	-	light-emitting diode	connected to lift call button	No	
ACC WC	ventilation exhaust only	-	light-emitting diode	motion sensors	No	
BIN Store	ventilation exhaust only	-	light-emitting diode	motion sensors	No	
Services	no mechanical ventilation	-	light-emitting diode	manual on / manual off	No	
Entry & hallways	no mechanical ventilation	-	light-emitting diode	motion sensors	No	
FS (All levels)	no mechanical ventilation	-	light-emitting diode	motion sensors	No	

Central energy systems	Туре	Specification
Central hot water system (No. 1)	solar - electric boosted	Solar collector area (minimum, in square metres): 5.0 Piping insulation (ringmain & supply risers): (a) Piping external to building: R1.0 (~38 mm); (b) Piping internal to building: R1.0 (~38 mm)
Lift (No. 1)	gearless traction with V V V F motor	Number of levels (including basement): 6

4. Commitments for common areas and central systems/facilities for the development (non-building specific)

(b) Common areas and central systems/facilities

(i) Water	Show on DA plans	Show on CC/CDC plans & specs	Certifier check
(a) If, in carrying out the development, the applicant installs a showerhead, toilet, tap or clothes washer into a common area, then that item must meet the specifications listed for it in the table.		~	~
(b) The applicant must install (or ensure that the development is serviced by) the alternative water supply system(s) specified in the "Central systems" column of the table below. In each case, the system must be sized, be configured, and be connected, as specified in the table.	~	~	~
(c) A swimming pool or spa listed in the table must not have a volume (in kLs) greater than that specified for the pool or spa in the table.	~	~	
(d) A pool or spa listed in the table must have a cover or shading if specified for the pool or spa in the table.		~	
(e) The applicant must install each fire sprinkler system listed in the table so that the system is configured as specified in the table.		~	~
(f) The applicant must ensure that the central cooling system for a cooling tower is configured as specified in the table.		~	~

Common area	Showerheads rating	Toilets rating	Taps rating	Clothes washers rating
All common areas	no common facility	4 star	6 star	no common laundry facility

(ii) Energy	Show on DA plans	Show on CC/CDC plans & specs	Certifier check
(a) If, in carrying out the development, the applicant installs a ventilation system to service a common area specified in the table below, then that ventilation system must be of the type specified for that common area, and must meet the efficiency measure specified.		~	~
(b) In carrying out the development, the applicant must install, as the "primary type of artificial lighting" for each common area specified in the table below, the lighting specified for that common area. This lighting must meet the efficiency measure specified. The applicant must also install a centralised lighting control system or Building Management System (BMS) for the common area, where specified.		~	~
(c) The applicant must install the systems and fixtures specified in the "Central energy systems" column of the table below. In each case, the system or fixture must be of the type, and meet the specifications, listed for it in the table.	~	~	~

Central energy systems	Туре	Specification	
Alternative energy supply	Photovoltaic system	Rated electrical output (min): 3.1 peak kW	

1. In these commitments, "applicant" means the perso	n carrying out the development.
	and common area listed in this certificate, on the plans accompanying any development application, and on the plans and construction certificate / complying development certificate, for the proposed development, using the same identifying letter or common area in this certificate.
	ves the erection of a building for both residential and non-residential purposes (or the change of use of a building for both nents in this certificate which are specified to apply to a "common area" of a building or the development, apply only to that part of tial purposes.
	ent for a dwelling or building, and that system will also service any other dwelling or building within the development, then that parately listed as a commitment for that other dwelling or building).
5. If a star or other rating is specified in a commitment	this is a minimum rating.
	nese commitments (if any), must be installed in accordance with the requirements of all applicable regulatory authorities. NOTE: , recycled water or private dam water be used to irrigate edible plants which are consumed raw, or that rainwater be used for pply.
egend	

2. Commitments identified with a "," in the "Show on CC/CDC plans and specs" column must be shown in the plans and specifications accompanying the application for a construction certificate / complying development certificate for the proposed development.

3. Commitments identified with a "," in the "Certifier check" column must be certified by a certifying authority as having been fulfilled. (Note: a certifying authority must not issue an occupation certificate (either interim or final) for a building listed in this certificate, or for any part of such a building, unless it is satisfied that each of the commitments whose fulfillment it is required to monitor in relation to the building or part, has been fulfilled).